
UNIVERSITI SAINS MALAYSIA

First Semester Examination
Academic Session 2008/2009

November 2008

RMG 336 – Quantity Surveying 1
(*Ukur Bahan 1*)

Duration: 3 hours
(Masa: 3 jam)

Please check that this examination paper consists of **TWENTY** pages of printed material before you begin the examination.

Sila pastikan bahawa kertas peperiksaan ini mengandungi DUA PULUH muka surat yang tercetak sebelum anda memulakan peperiksaan ini.

Students are allowed to answer all questions in English OR in Bahasa Malaysia.

Pelajar dibenarkan menjawab semua soalan dalam Bahasa Inggeris ATAU Bahasa Malaysia.

Answer **ALL** questions.

Jawab **SEMUA** soalan.

- 2 -

1. With reference to Electrical Installation Drawing (Drawing E1), you are required to produce Bill of Quantities (BQ) of electrical installation for one unit of ground floor office shop (Plot 1). Please ignore the veranda area.

Merujuk kepada Lukisan Pemasangan Elektrik (Lukisan E1), anda diminta untuk menyiapkan senarai kuantiti (BQ) untuk pemasangan elektrik bagi tingkat bawah kedai pejabat. Anda hanya perlu mengira untuk satu unit kedai pejabat sahaja (Plot 1). Sila abaikan kawasan beranda.

(100 marks/markah)

2. (a) Measure all the items connected with concreting works (in-situ concrete, formwork and reinforcement) for Roof Beam RB5 based on Drawings X1, X2 and X3 and the following information:-

(i)	Concrete:	substructure superstructure	Grade 40 Grade 25
(ii)	Concrete cover:	substructure superstructure	40 mm 25 mm
(iii)	Dimensions of Column C1 and C2		400 x 400

- (b) The height of the beam from the floor is not indicated in the drawings given. Please state and elaborate the specific clauses in SMM2 which requires you to consider the height when measuring in-situ reinforced concrete beams.

- (a) *Ukur segala item yang berkaitan dengan kerja-kerja konkrit (konkrit in-situ, acuan dan tetulang) untuk Rasuk Bumbung RB5 berdasarkan Lukisan X1, X2 dan X3 dan maklumat berikut:-*

(i)	Konkrit:	substruktur superstruktur	Gred 40 Gred 25
(ii)	Lapisan Luar Konkrit:	substruktur superstruktur	40 mm 25 mm
(iii)	Dimensi Kolumn C1 dan C2		400 x 400

- (b) *Ketinggian rasuk daripada lantai tidak diberikan dalam lukisan yang diberikan. Sila nyata danuraikan klausa spesifik dalam SMM2 yang memerlukan anda ambilkira ketinggian apabila mengukur rasuk konkrit tetulang in-situ.*

(100 marks/markah)

...3/-

- 3 -

3. Write short notes on how the following works are to be treated in the tender document in accordance to SMM2. State the relevant clause/clauses.
- (a) The use of the Main Contractor's standing scaffolding, storage, temporary lighting and water.
 - (b) Works such as notices and fees to statutory authorities, clearing away and making good and maintaining temporary works.
 - (c) The client's own contractor will install the removable partition to ballroom. Will this work be included in the tender document? If so, in which section of the document?
 - (d) The client will nominate a supplier to supply ceramic floor tiles for Project ABC. In what manner shall the supply of ceramic floor tiles be reflected in the tender document?

Telitikan senarai kerja-kerja yang disenaraikan di bawah. Terangkan secara ringkas panduan yang digariskan dalam SMM2 untuk kerja-kerja di bawah. Nyatakan klausula yang berkaitan.

- (a) *Penggunaan "scaffolding" yang sediada, tempat penyimpanan, bekalan lampu dan air sementara.*
- (b) *Kerja-kerja seperti notis dan yuran kepada pihak berkuasa, pembersihan sampah pembinaan dan pembekalan kerja sementara.*
- (c) *Pihak klien mempunyai kontraktor sendiri yang akan memasang dinding sekatan di dewan utama. Adakah kerja ini termasuk di dalam dokumen tender? Sekiranya ya, kerja tersebut akan dimasukkan dalam bahagian apa?*
- (d) *Pihak klien akan menamakan seorang pembekal untuk membekalkan jubin seramik kepada Projek ABC. Bagaimanakah bekalan jubin seramik ini akan ditunjukkan dalam dokumen tender?*

(100 marks/markah)

...4/-

- 4 -

4. (a) In accordance with Drawings R1, R2, R3, R4 and R5, measure all the items relating to roof coverings and rainwater goods.

Berpandukan kepada Lukisan R1, R2, R3, R4 dan R5, ukurkan item-item penutup bumbung dan kemudahan air hujan.

- (b) Attach a Query List into your answer script to explain any assumption you make, based on the given drawings.

Kepilkhan "Query List" ke dalam kertas jawapan anda untuk menjelaskan apa-apa anggapan yang anda buat berdasarkan lukisan-lukisan yang diberikan.

(100 marks/markah)

5. In accordance with Drawings DW.1, DW.2, DW.3, DW.4, DW.5, DW.6, DW.7:-

- (a) Prepare the taking-off lists for the measurement of Doors and Windows items.

- (b) Describe the clauses relating to the Doors and Windows items in the Standard Method of Measurement 2 (SMM2) that you referred to for the preparation of your taking-off and discuss the principles for the measurement of these items.

Berdasarkan kepada Lukisan-Lukisan DW.1, DW.2, DW.3, DW.4, DW.5, DW.6, DW.7:-

- (a) *Sediakan senarai 'taking-off' bagi pengukuran item Tingkap dan Pintu.*


- (b) *Jelaskan klausa-klausa yang berkaitan dengan Tingkap dan Pintu dalam Standard Method of Measurement (SMM2) yang anda rujuk dalam penyediaan 'taking-off', dan bincangkan prinsip-prinsip pengukuran item-item tersebut.*

(100 marks/markah)

....5/-

Question 1


(Soalan 1)

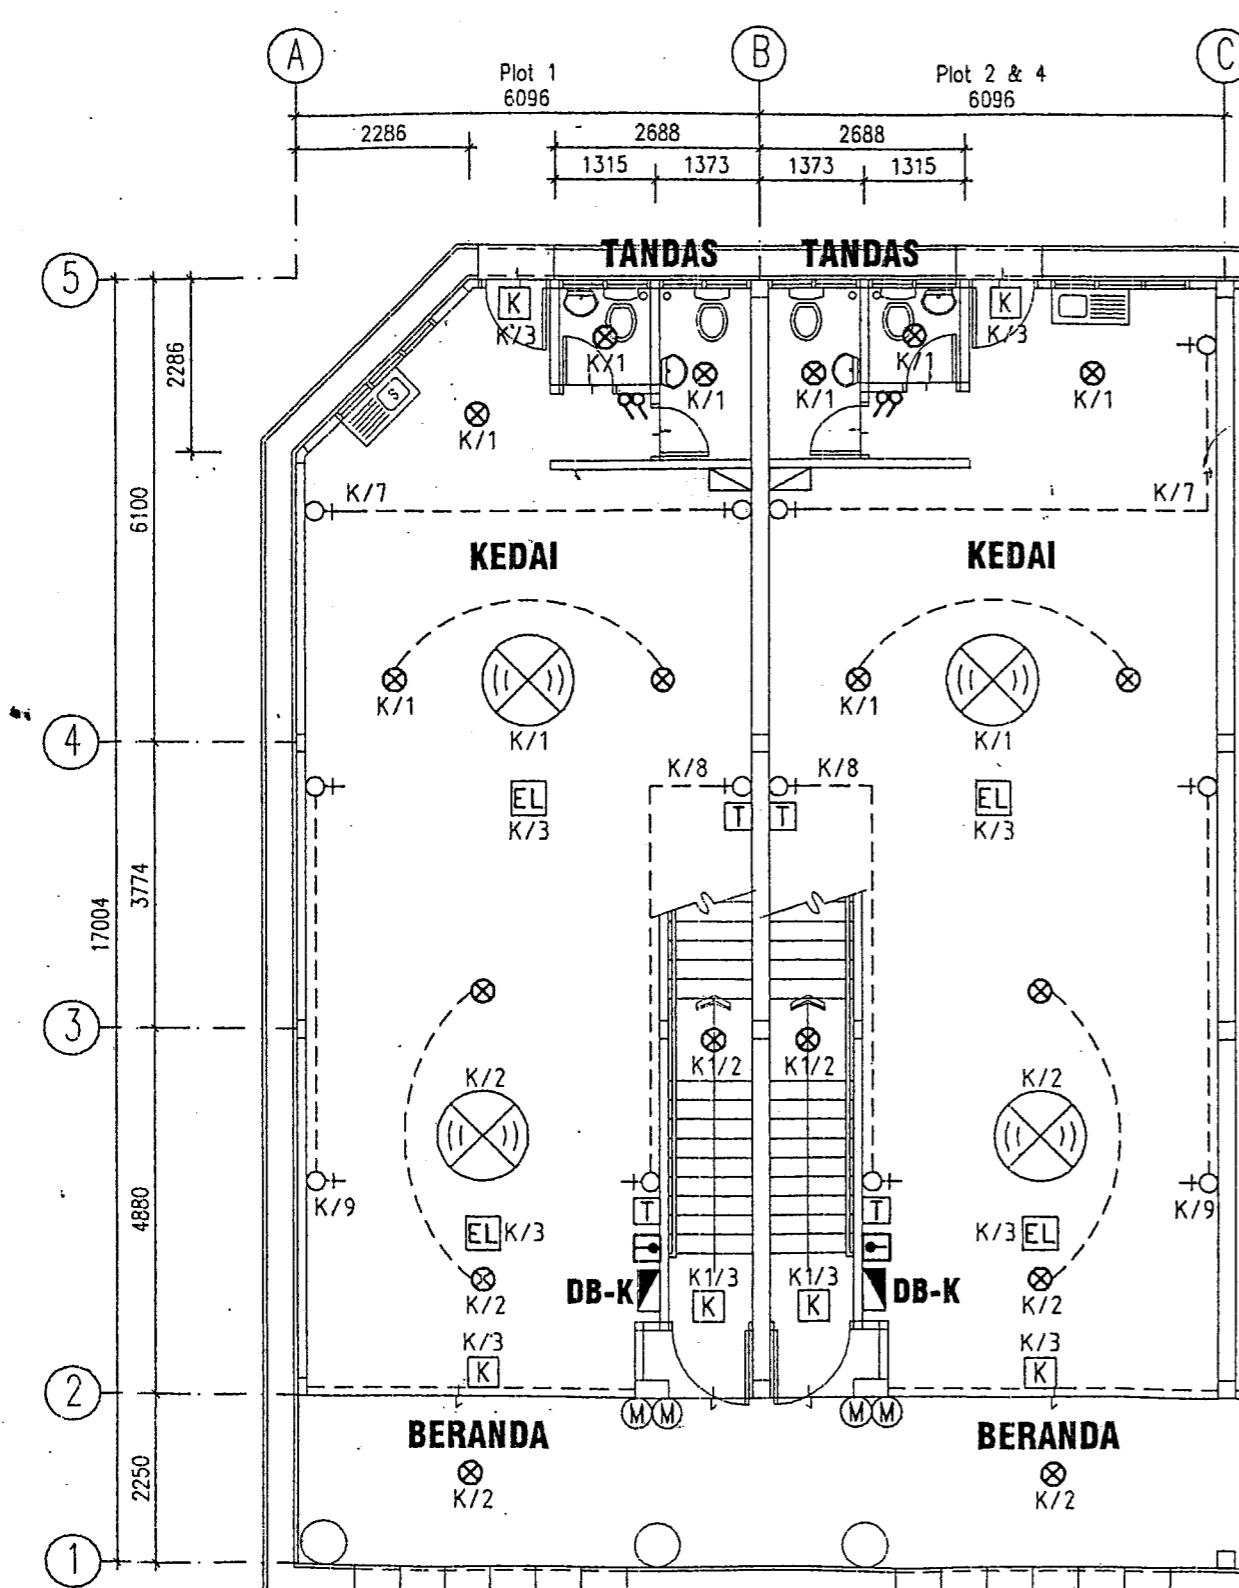

99

PELAN TINGKAT BAWAH

- 5 -

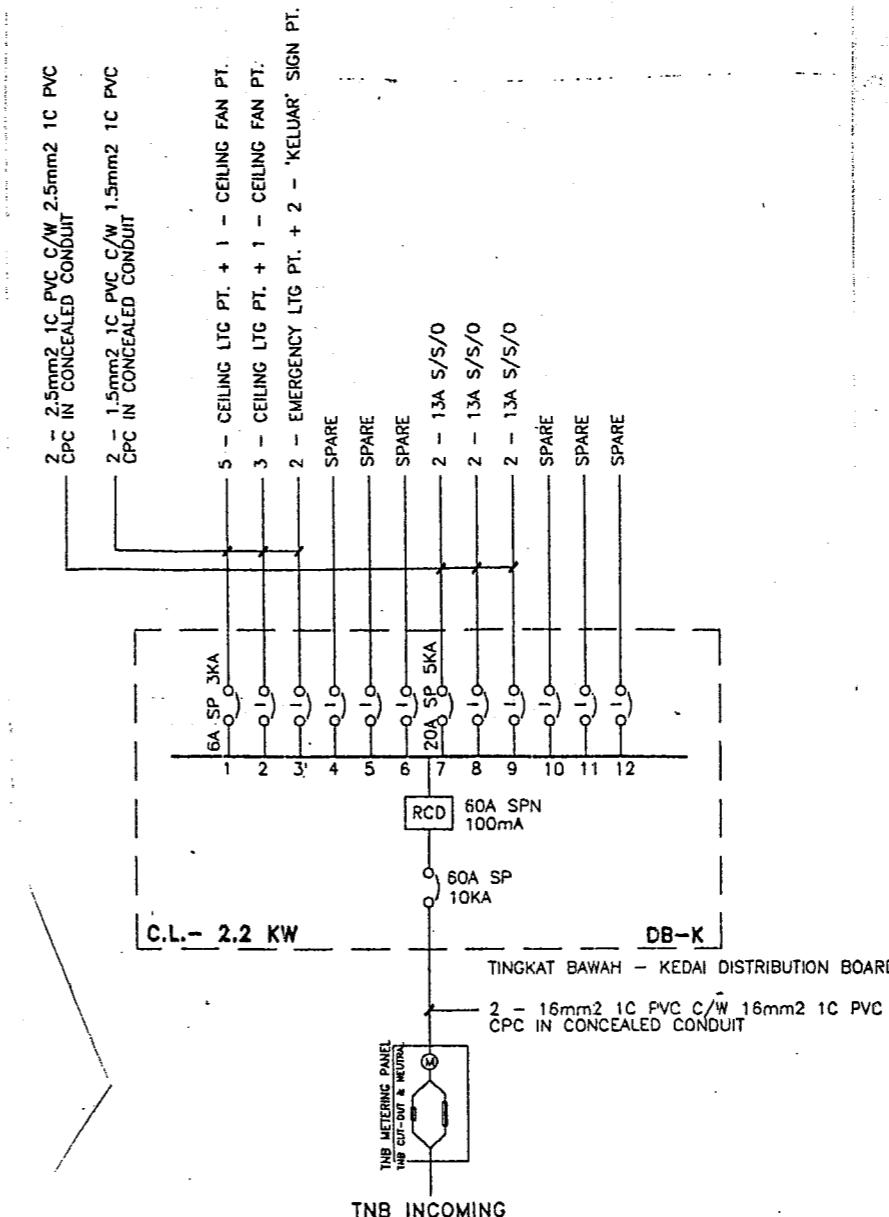

DRAWING E1


[RMG 336]

TITLE:

**ELECTRICAL INSTALLATION
KEDAI PEJABAT 2 TINGKAT
- PELAN LANTAI TINGKAT BAWAH
- SCHEMATIC SINGLE LINE**


...6/-

Drawings X1 (*Lukisan X1*)


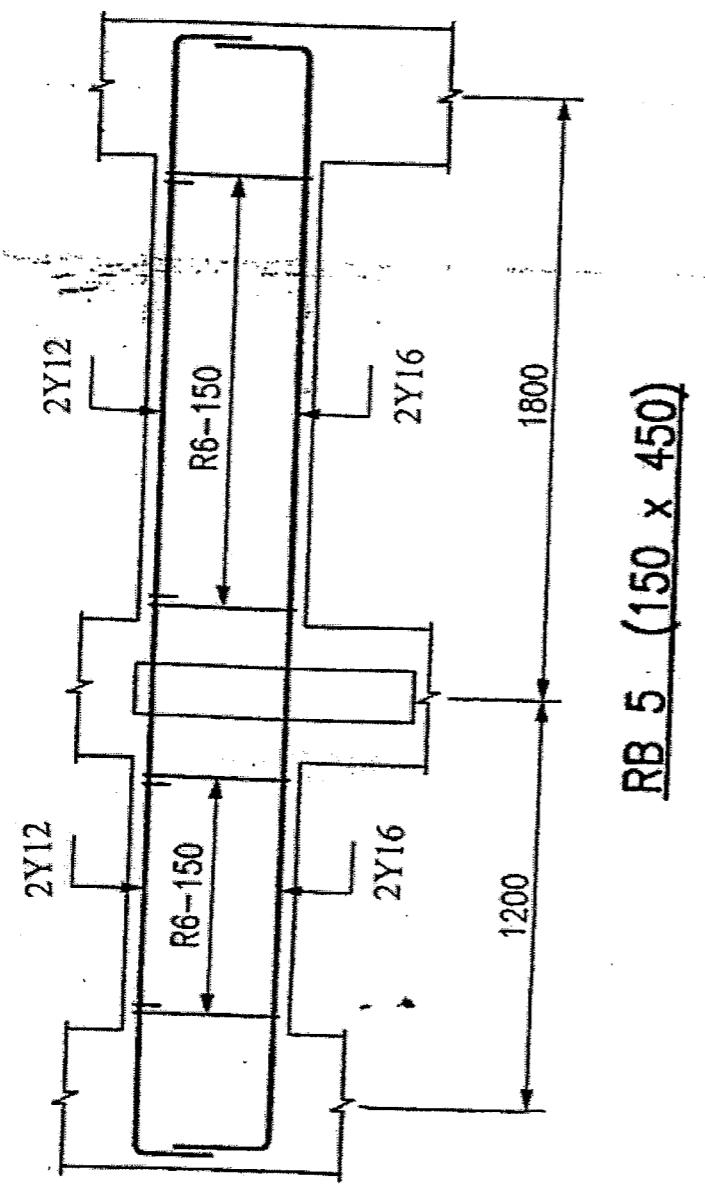


RB 5 (150 x 450)

Drawings X2 (Lukisan X2)

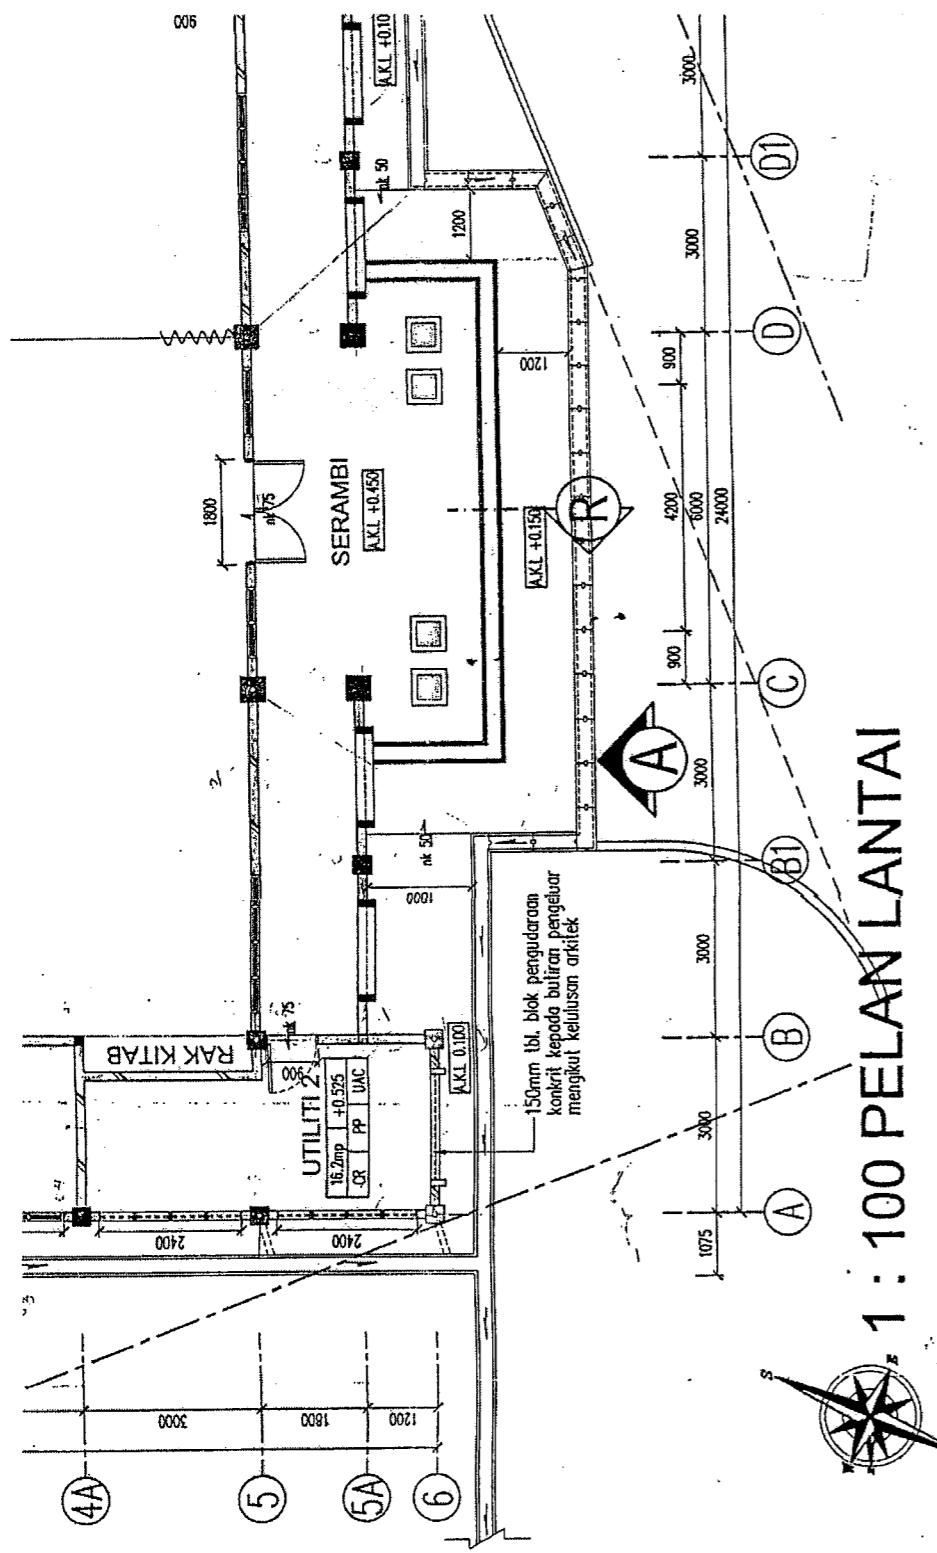


Drawings X3 (Lukisan X3)

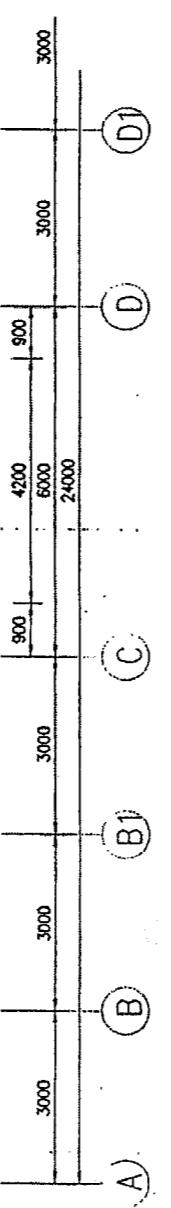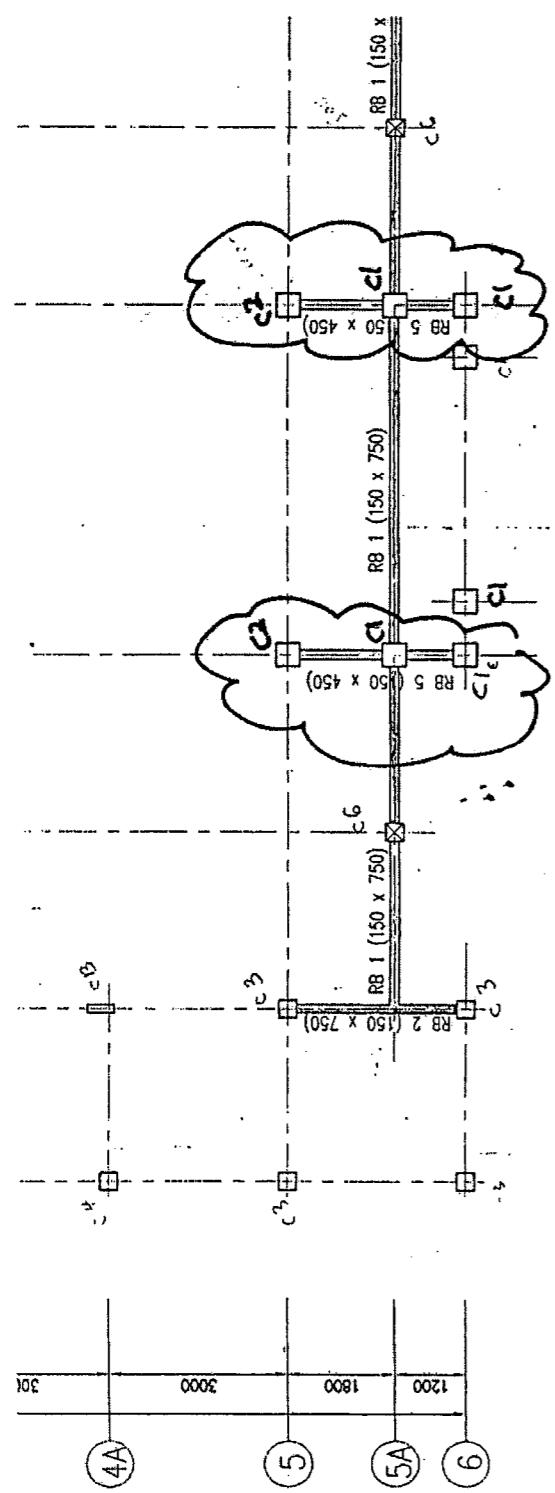

PELAN BUMBUNG

DRAWING R1


[RMG 336]

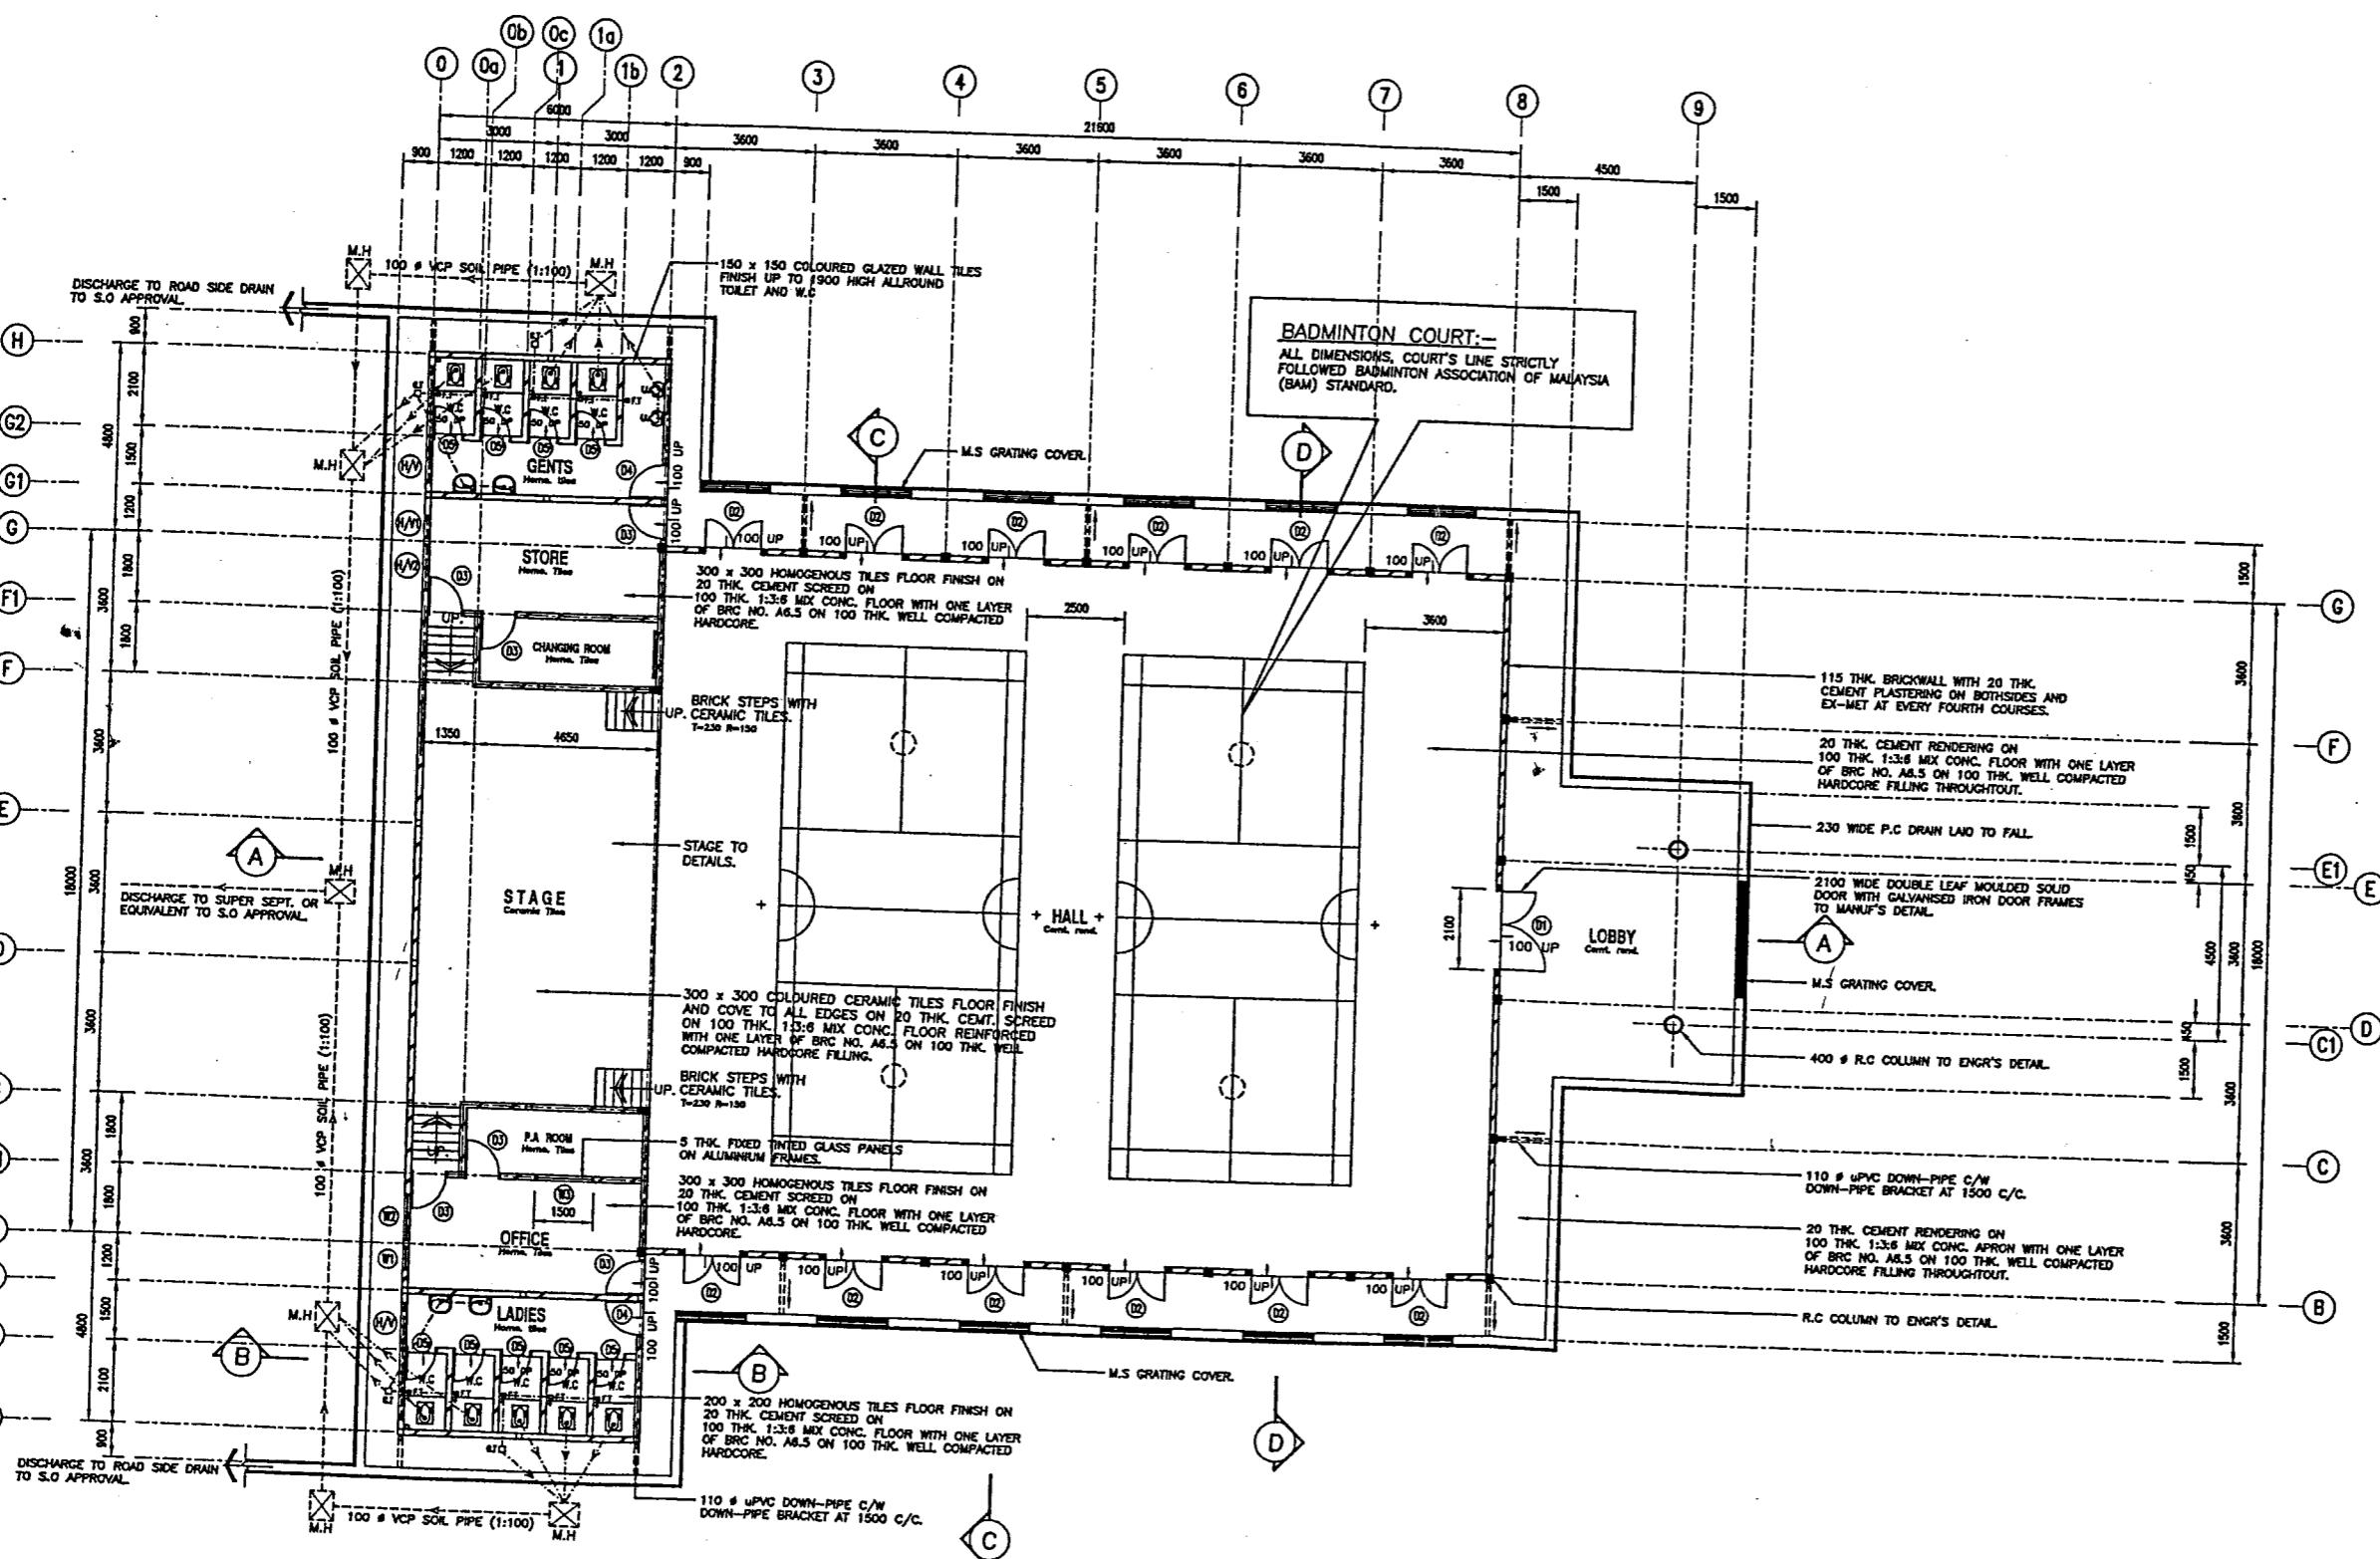


GROUND FLOOR PLA 1:100

- 10 -


[RMG 336]

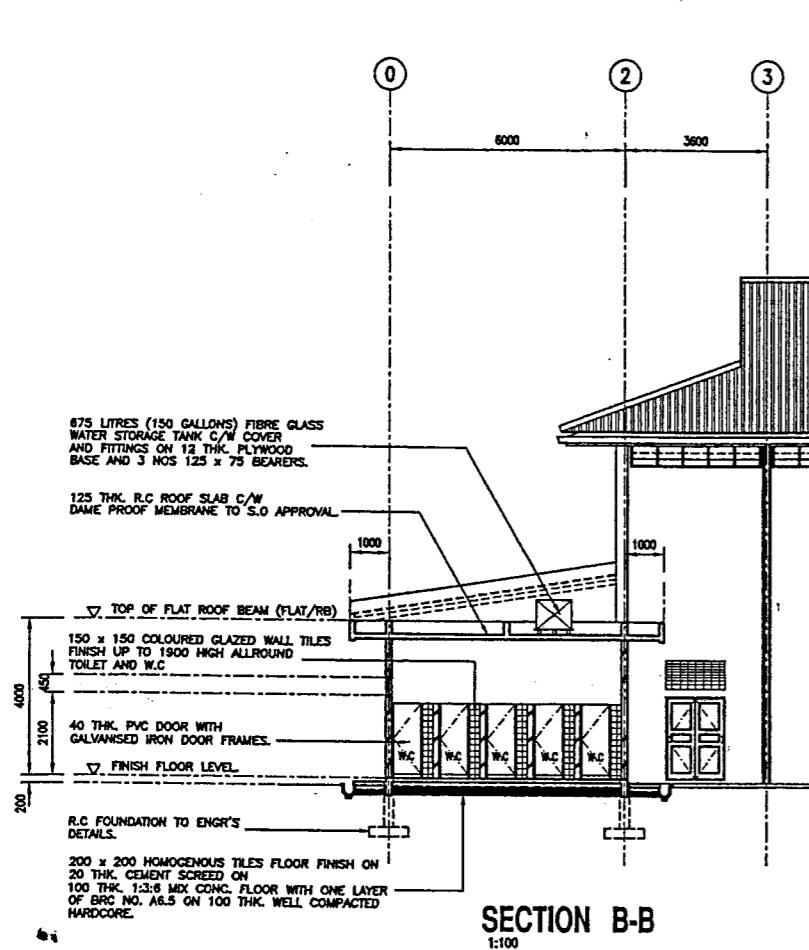

SECTION B

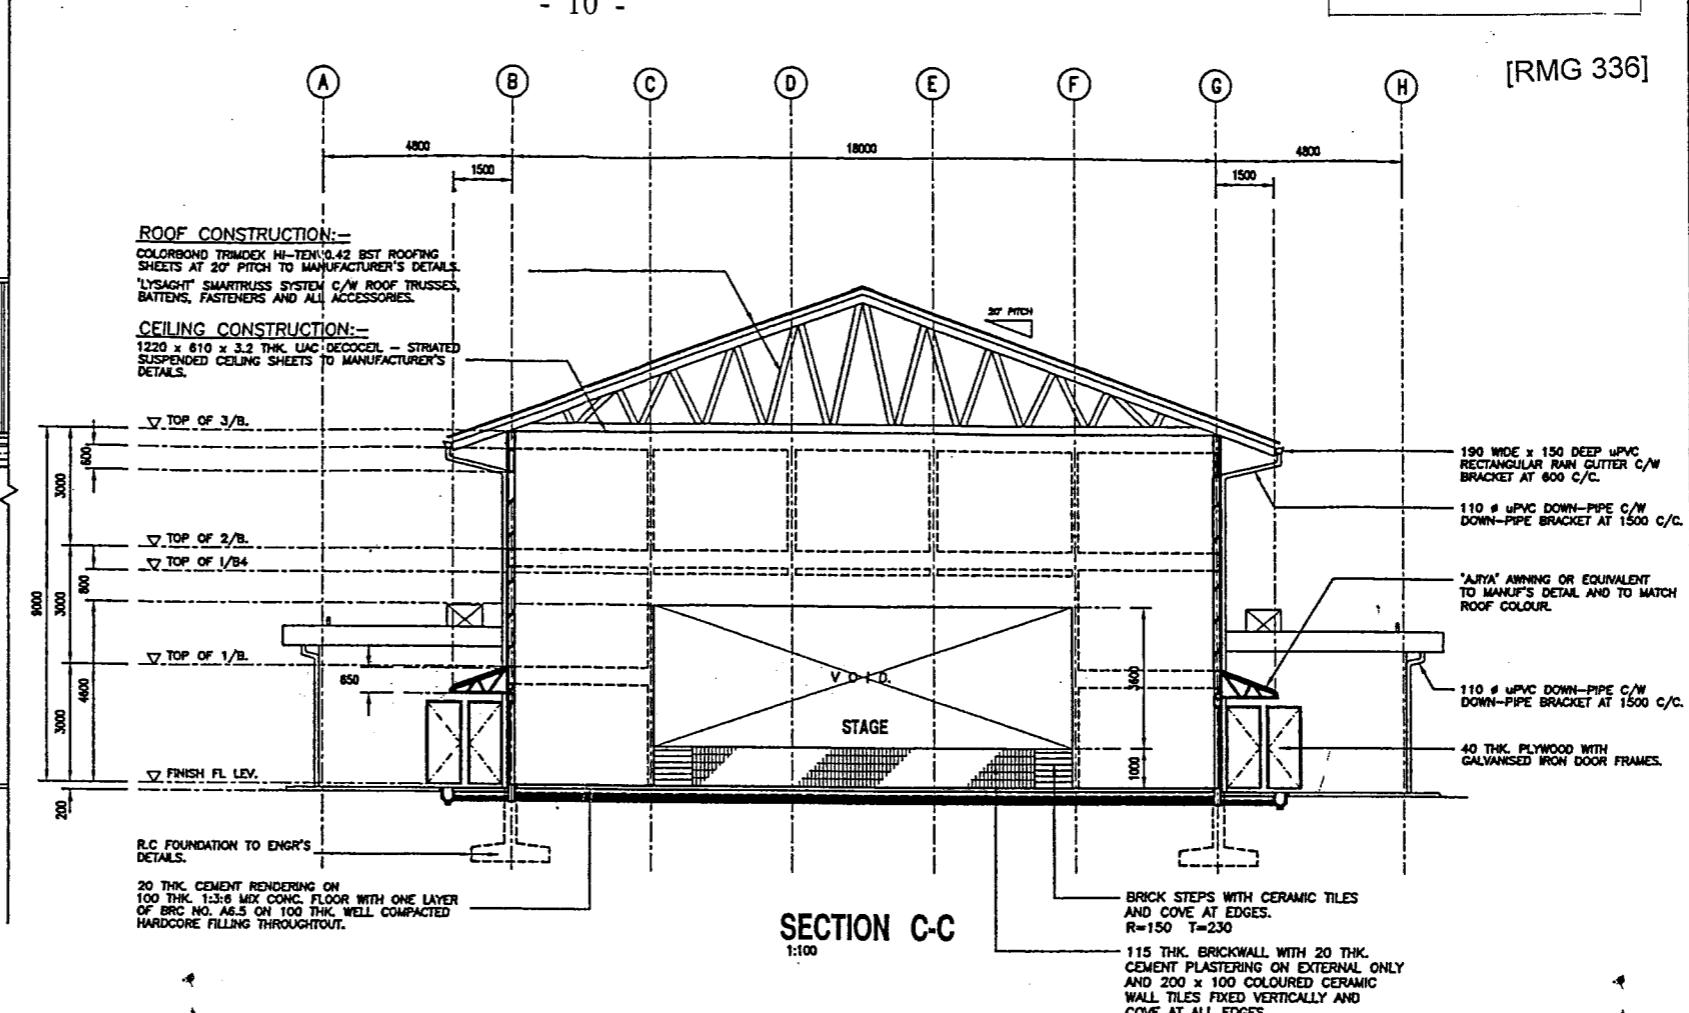


SECTION C-C

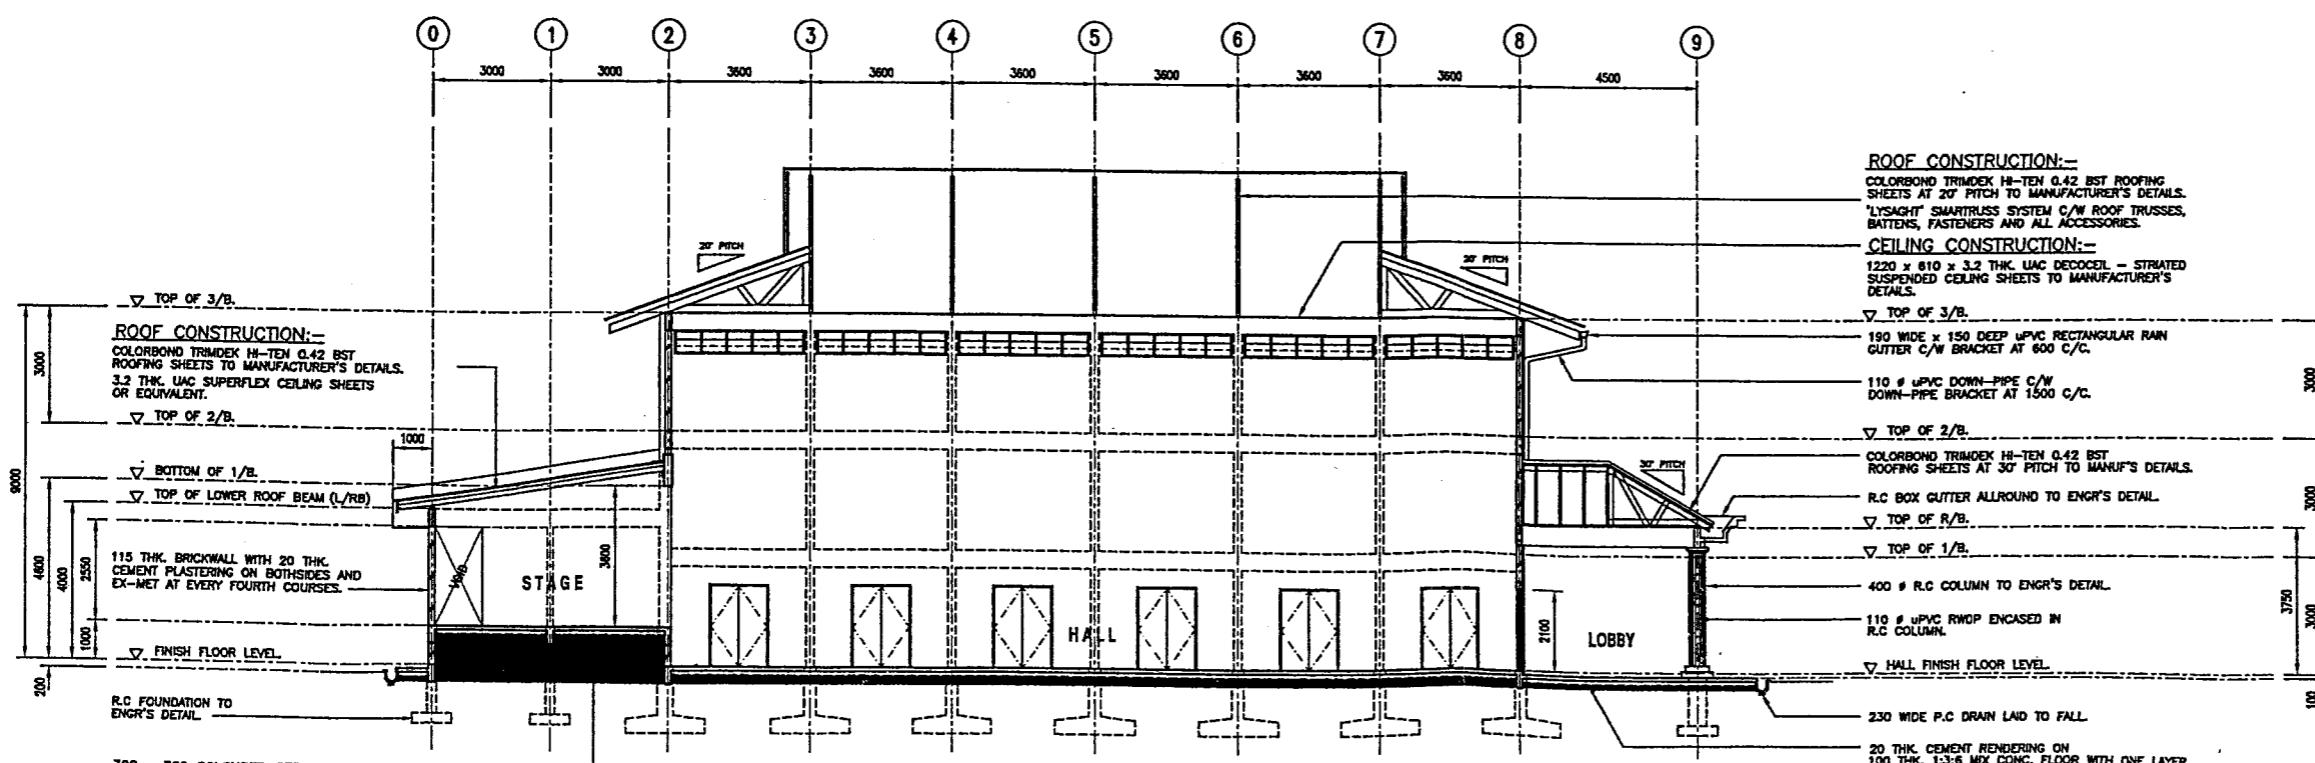

SECTION A-
1:100

109

...11/-

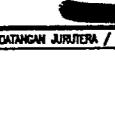Dwg. No.	REFERENCE DRAWINGS		
PROJECT			
CADANGAN PEMBINAAN DEWAN ORANG RAMAI. (TYPE 'A')			
TARIK / TITLE			
SECTIONS.			
TANDATANGAN PEMILIK / OWNER'S SIGNATURE			
ISSUE FOR BID	ISSUE FOR APPROVAL	APPROVED FOR CONSTRUCTION DATE PROJECT MANAGER	
PENGURUS PROJEK / PROJECT MANAGER			
			
TANDATANGAN JURUTERA / ENGINEER'S SIGNATURE			
DESIGNED BY	H.J. NASIR	DATE	
DESIGN CHKD BY		DATE	
DRAWN BY	ZAILAN	DATE	JAN. 06
DWG CHKD BY	SAINI	DATE	
SCALE	1=100		
JOB NO:	DRAWING NO.		ISSUE
	BK/B/377/05/3-29		T

- 11 -

ROOF CONSTRUCTION:-
COLORBOND TRIMDEX HI-TEN 0.42 BST ROOFING SHEETS AT 20° PITCH TO MANUFACTURER'S DETAILS.
LYSAGHT SMARTRUS SYSTEM C/W ROOF TRUSSES, BATTENS, FASTENERS AND ALL ACCESSORIES.

CEILING CONSTRUCTION:-
1220 x 610 x 3.2 THK UAC DECOCEIL - STRIATED SUSPENDED CEILING SHEETS TO MANUFACTURER'S DETAILS.

▽ TOP OF 3/B.
600
3000
600
8 THK. FIXED CLEAR GLASS VENT ON GALVANISED IRON WINDOW FRAMES TO MANUF'S DETAIL

▽ TOP OF 2/B.
3000
750
▽ TOP OF 1/B6
750
▽ TOP OF 1/B6
300
2100 WIDE DOUBLE LEAF MOULDED SOLID DOOR TO MANUF'S DETAIL C/W GALVANISED DOOR FRAMES

200
FINISH FL. LEV.


R.C. FOUNDATION TO ENGR'S DETAIL

20 THK. CEMENT RENDERING ON
100 THK. 1:3:6 MIX CONC. FLOOR WITH ONE LAYER
OF BRC NO. A6.5 ON 100 THK. WELL COMPACTED
HARDCORE FILLING THROUGHTOUT.

1500
18000
1500
20° PITCH
190 WIDE X 150 DEEP UPVC RECTANGULAR RAIN GUTTER C/W BRACKET AT 600 C/C.
110 UPVC DOWN-PIPE C/W DOWN-PIPE BRACKET AT 1500 C/C.
113 THK. BRICKWALL WITH 20 THK. CEMENT PLASTERING ON BOTH SIDES AND EX-MET AT EVERY FOURTH COURSES.
'AJYA' AWNING OR EQUIVALENT TO MANUF'S DETAIL AND TO MATCH ROOF COLOUR.
1500 WIDE DOUBLE LEAF MOULDED SOLID DOOR TO MANUF'S DETAIL.
230 WIDE P.C. DRAIN LAID TO FALL.

SECTION D-D


SECTION D-1

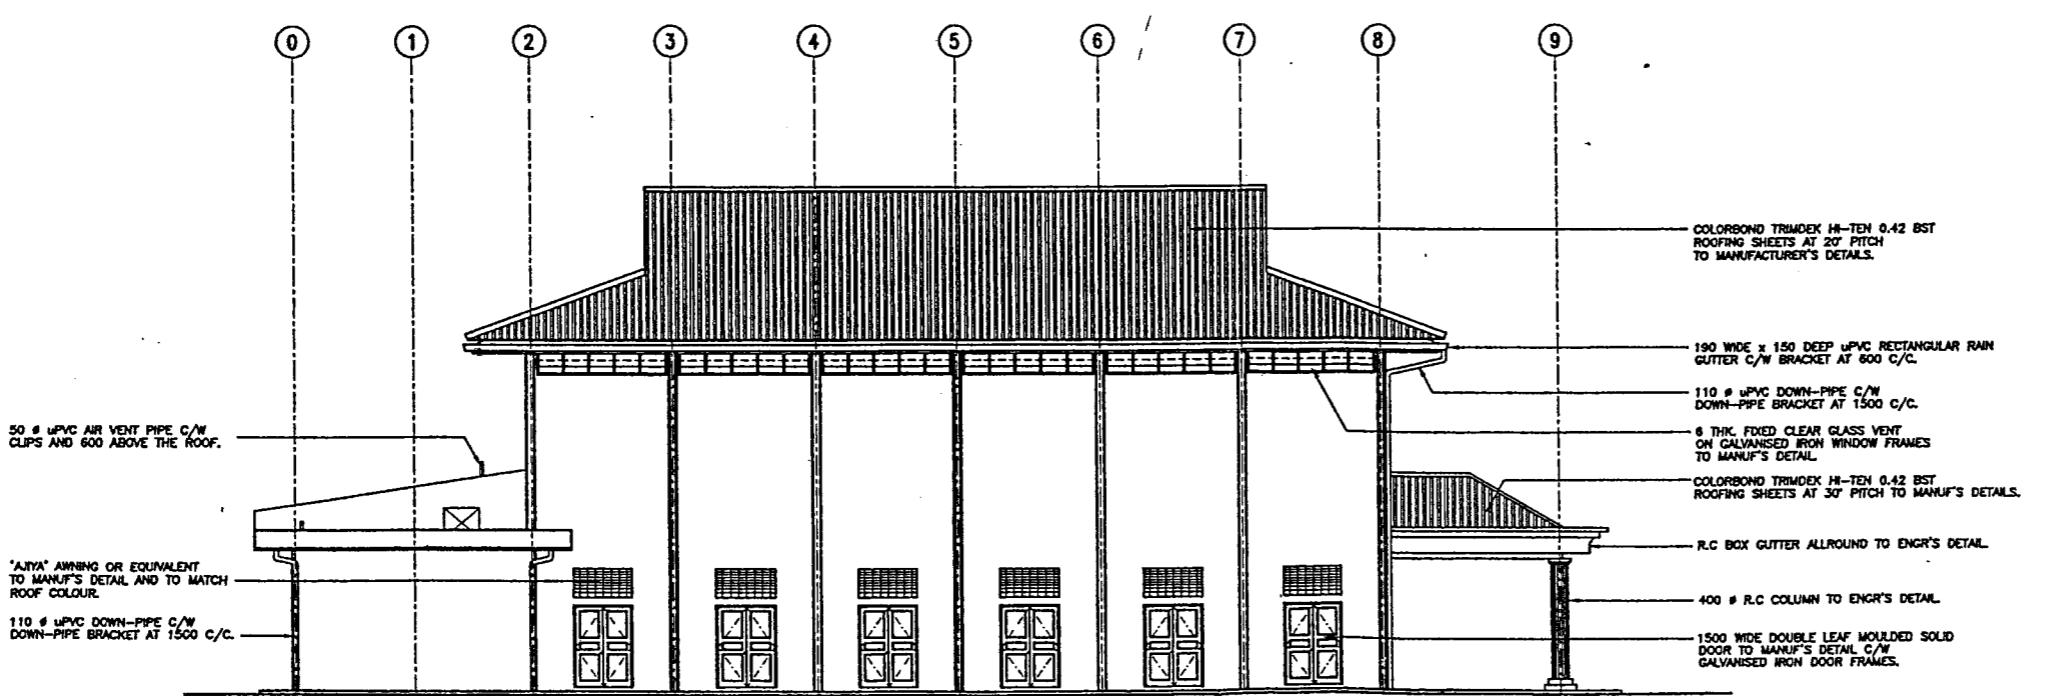

SIDE ELEVATION SIMILAR


DESIGNED BY	H.J. NASIR -	DATE	
DESIGN CHK'D BY		DATE	
DRAWN BY	ZAILAN	DATE	JAN. 06
DRAWING CHK'D BY	SAINI	DATE	
SCALE	1=100		
JOB NO:	DRAWING NO.	ISSUE	

RMG 336]

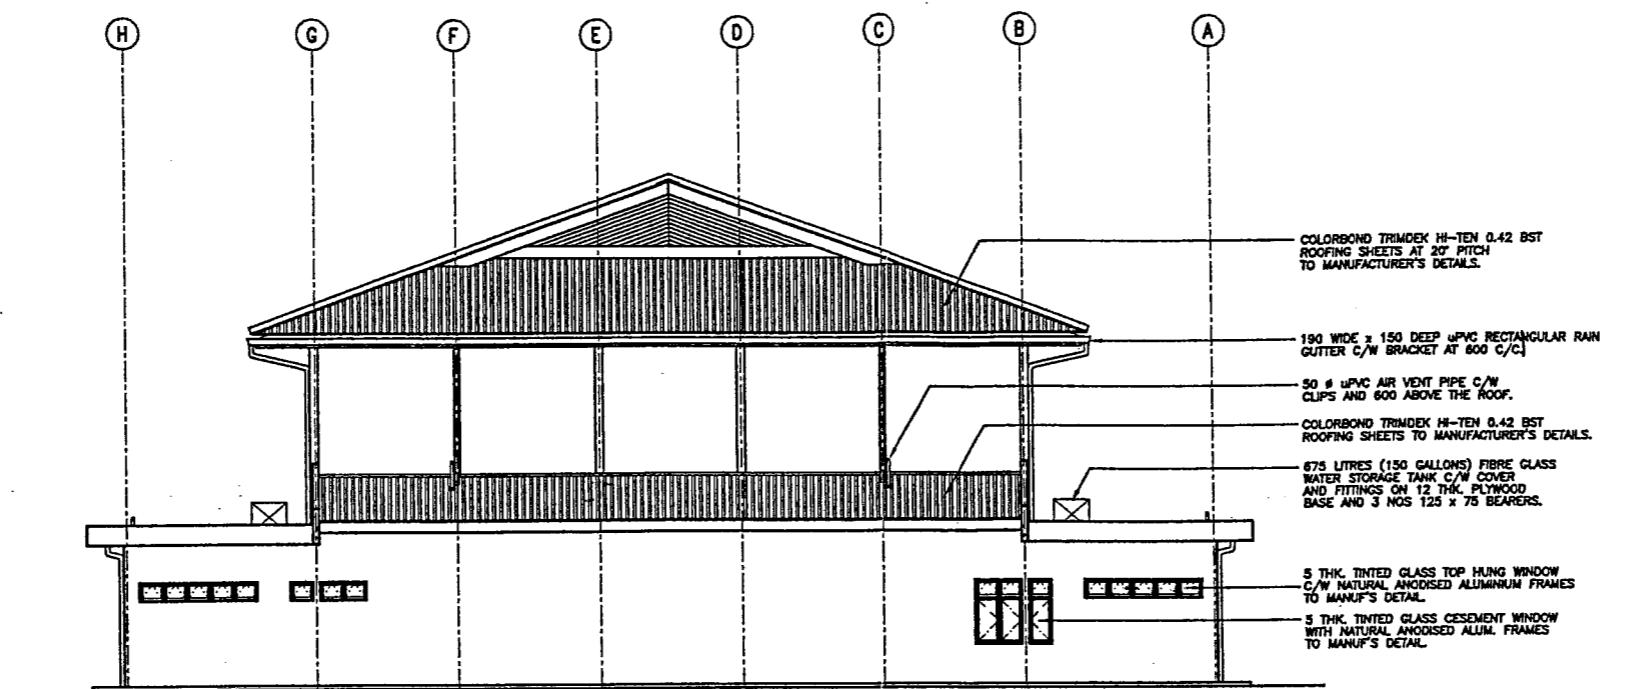

REAR ELEVATION

1

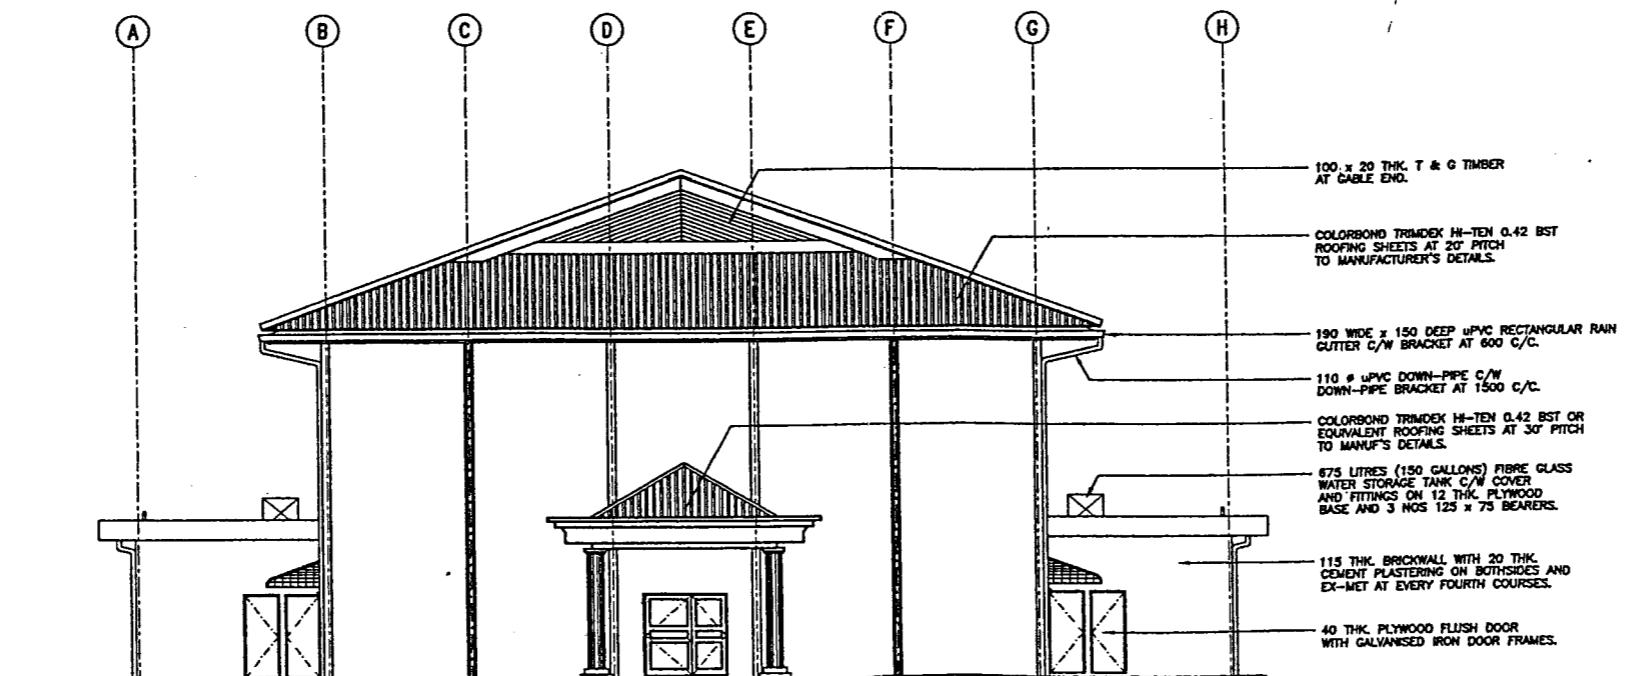

FRONT ELEVATION

113

...13/-

**CADANGAN PEMBINAAN
DEWAN ORANG RAMAI.
(TYPE 'A')**

TASK / TITLE

ISSUE FOR BID	ISSUE FOR APPROVAL	APPROVED FOR CONSTRUCTION DATE	PROJECT MANAGER
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PENGARIS PROJEK / PROJECT MANAGER

[REDACTED]

[REDACTED]


[REDACTED]

[REDACTED]

TANDATANGAN JURUTERA / ENGINEER'S SIGNATURE

DESIGNED BY	H.J. NASIR	DATE
DESIGN CHKD BY		DATE
DRAWN BY	ZAILAN	DATE
DWG CHKD BY	SAINI	DATE
SCALE	1=100	
DRW NO.	DRAWING NO.	ISSUE

[RMG 336]

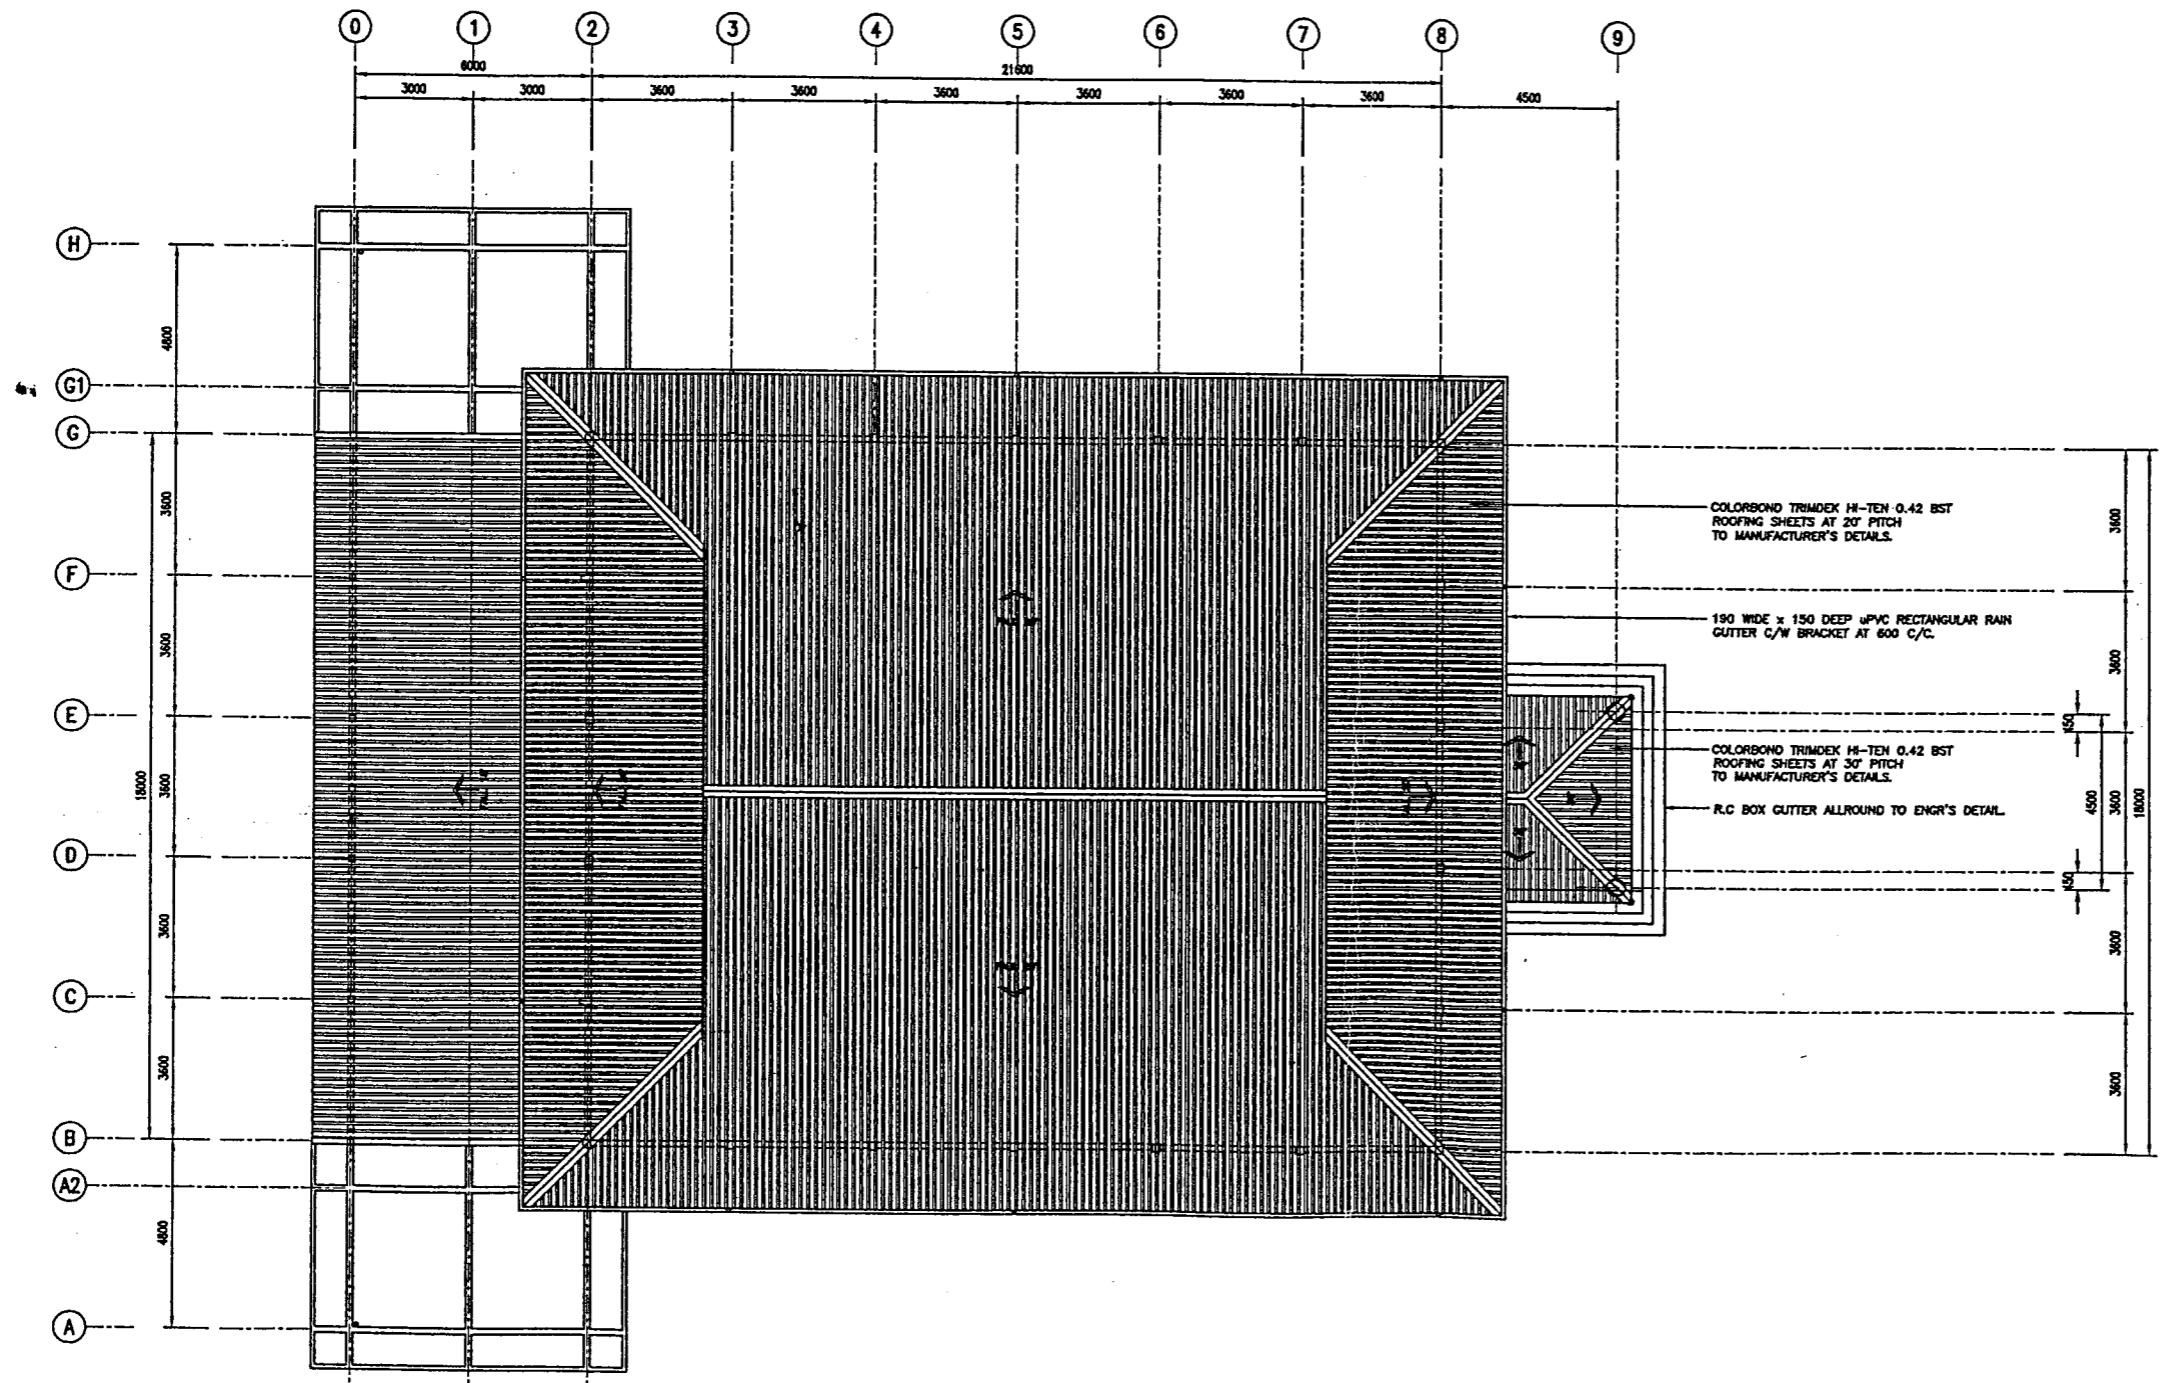

ROOF PLATE

115

....14/-

**CADANGAN PEMBINAAN
DEWAN ORANG RAMAI.
(TYPE 'A')**

ROOF PLAN


TANDATANGA PEMILIK / OWNER'S SIGNATURE

ISSUE FOR BID **ISSUE FOR APPROVAL** **APPROVED FOR CONSTRUCTION**

PENGURUS PROJEK / PROJECT MANAGER

TANDATANGAN JURUTERA / ENGINEER'S SIGNATURE

DESIGNED BY	H.J. NASIR	DATE
DESIGN CHK'D BY		DATE
DRAWN BY	ZAILAN	DATE
DWG CHK'D BY	SAINI	DATE
SCALE	1:100	

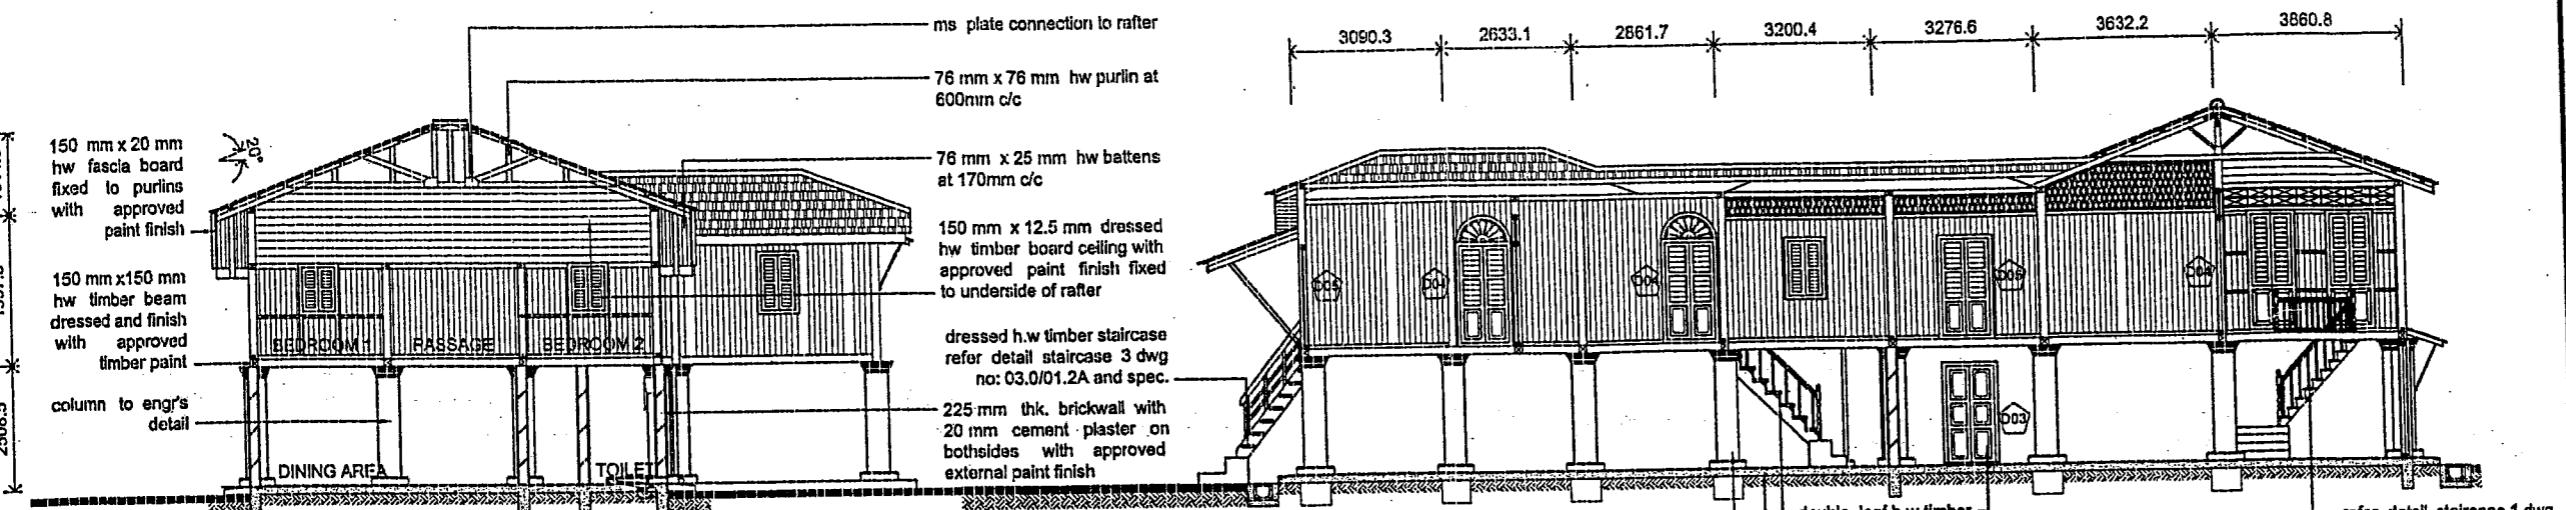


SECTION B-B

double leaf h.w timber panel door painted with approved paint finish
refer detail staircase 1 dwg. no: 03.0/01.1A & 03.0/01.1B


refer detail staircase 2 drawing no: 03.0/01.2A

r.c floor to eng'r's detail


column to eng'r's detail

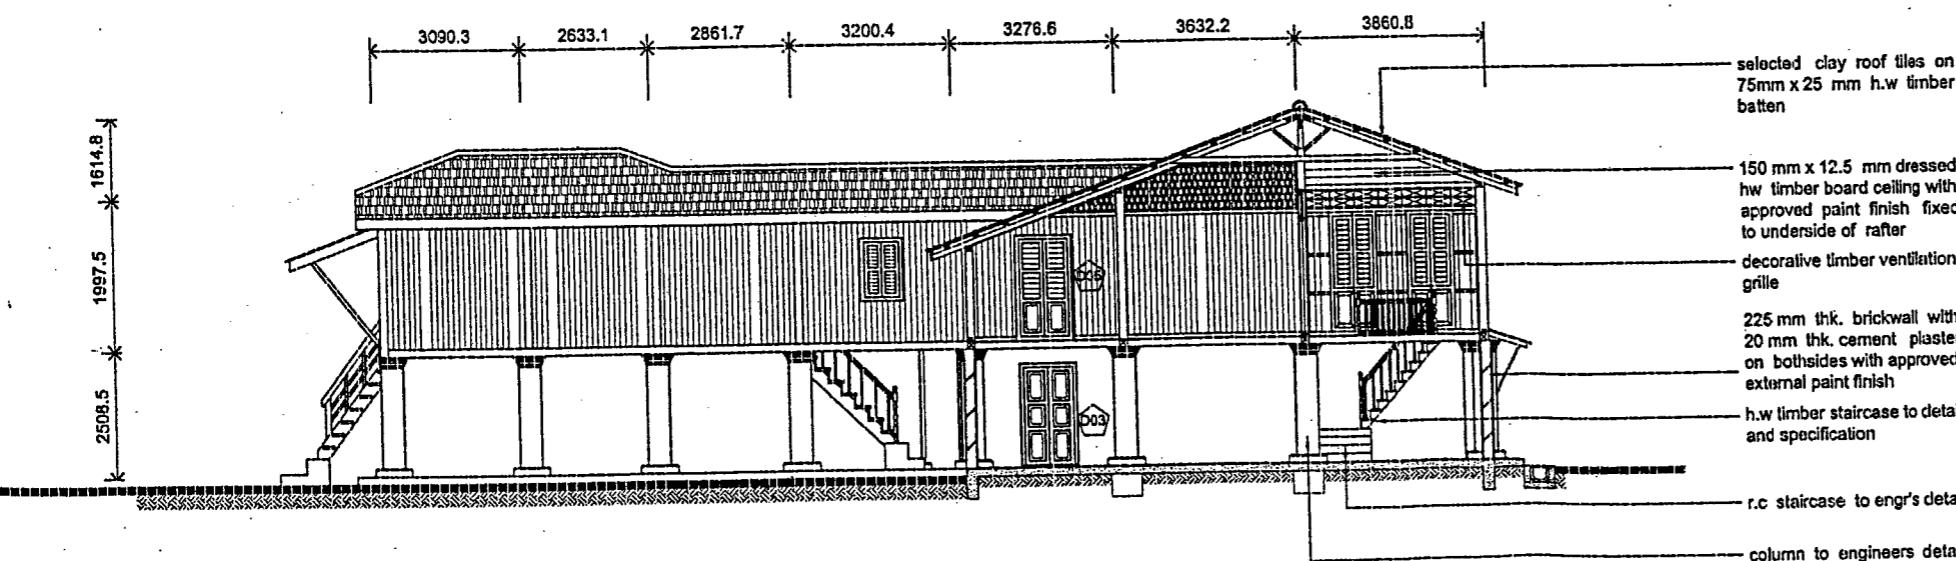


DRAWING NUMBER: DW/1

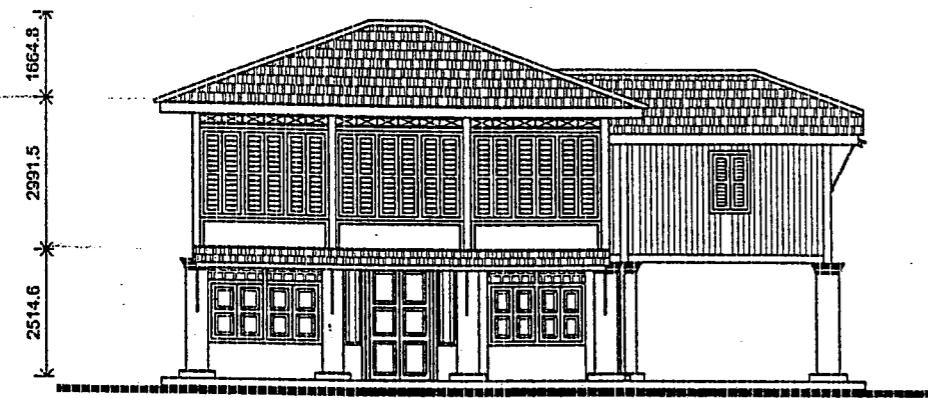


04 FRONT ELEVATION
Scale 1:75

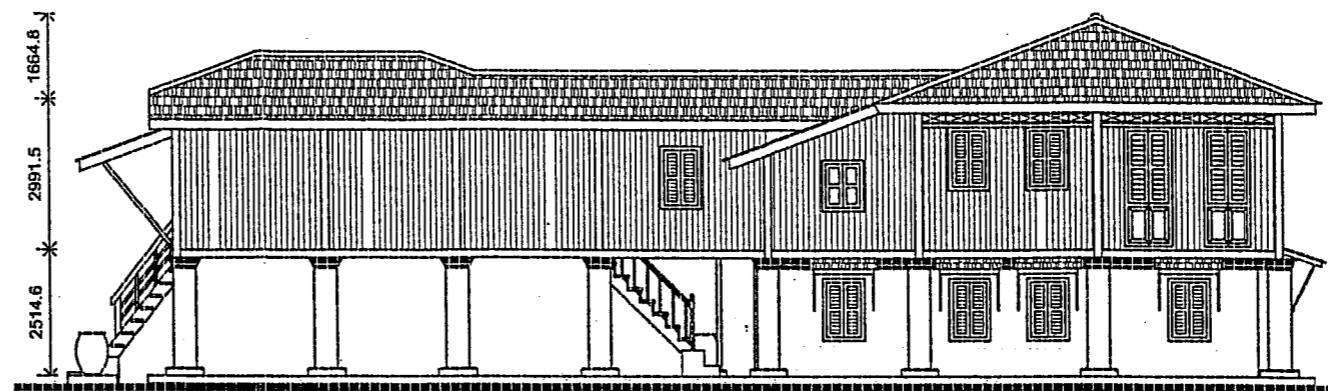




06 LEFT ELEVATION
Scale 1:75

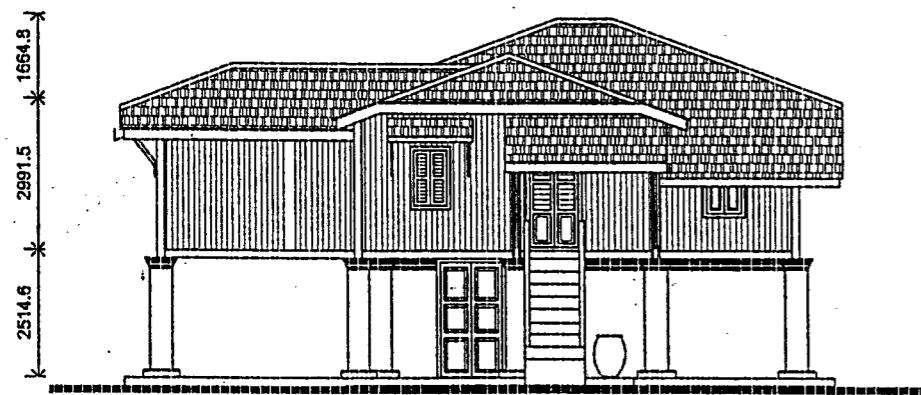

05 REAR ELEVATION
Scale 1:75



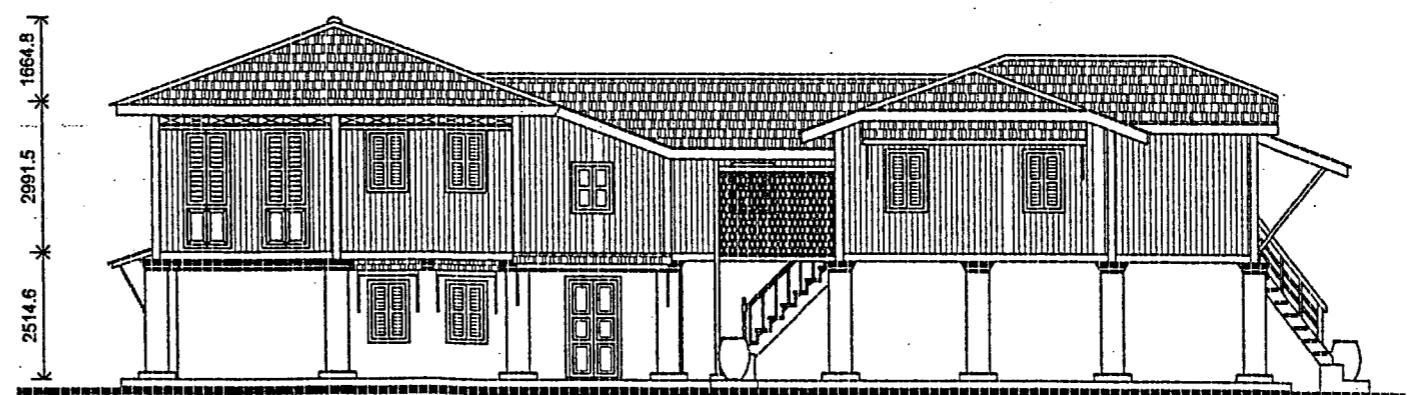


07 RIGHT ELEVATION
Scale 1:75

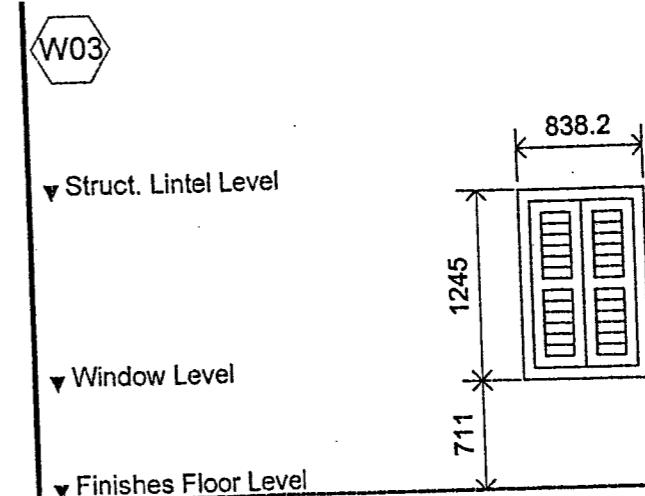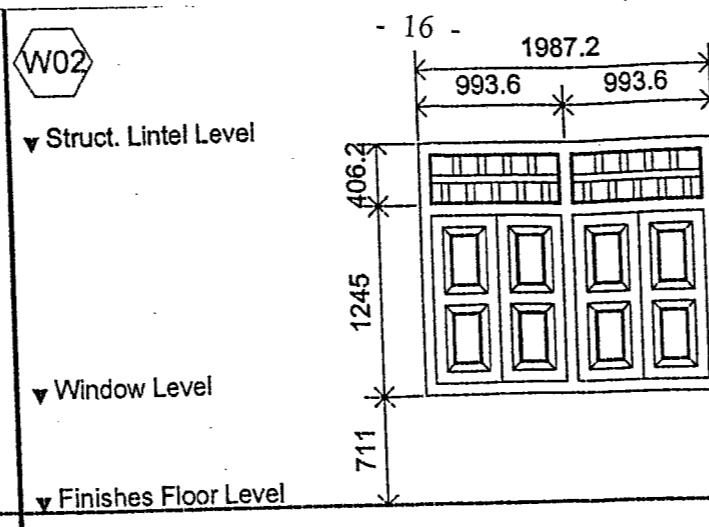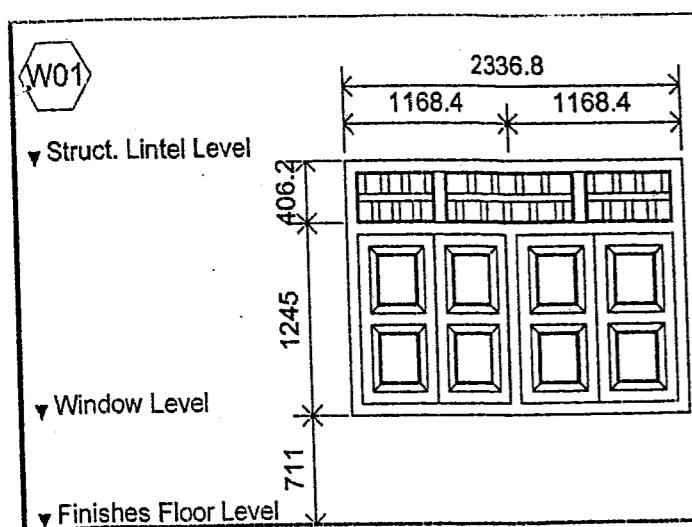

DESCRIPTION	2336.8 mm width x 1245 mm high (total length) double leaf h.w. timber panel window with approved paint finish	DESCRIPTION	1987.2 mm width x 1245 mm high (total length) double leaf h.w. timber panel window with approved paint finish	DESCRIPTION	838.2 mm width x 1245 mm high (total length) double leaf h.w. timber panel louvres window with approved paint finish
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LOCATION	QUANTITY	LOCATION	QUANTITY	LOCATION	QUANTITY
GROUND FLOOR	1	GROUND FLOOR	1	GROUND FLOOR	6
FIRST FLOOR	-	FIRST FLOOR	-	FIRST FLOOR	-
TOTAL	1	TOTAL	1	TOTAL	6

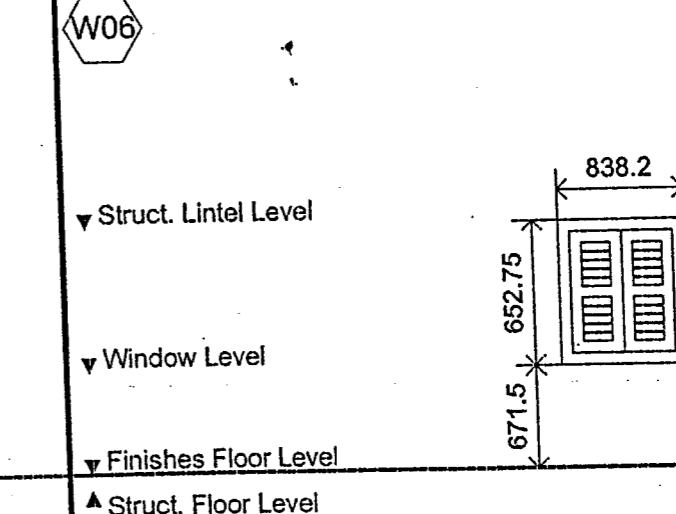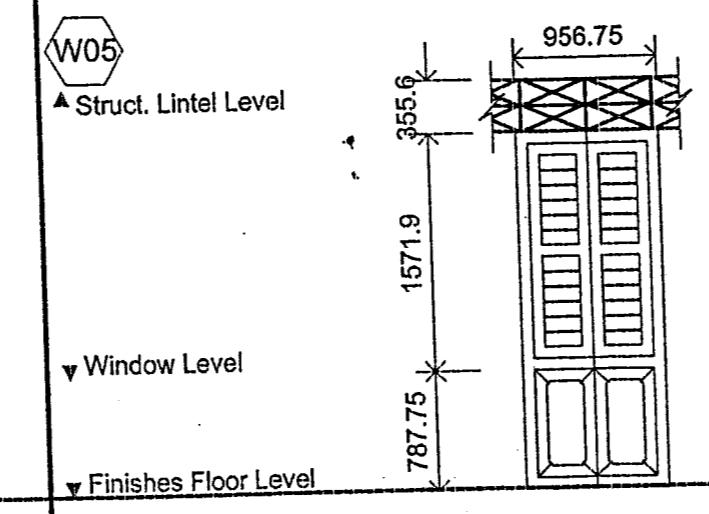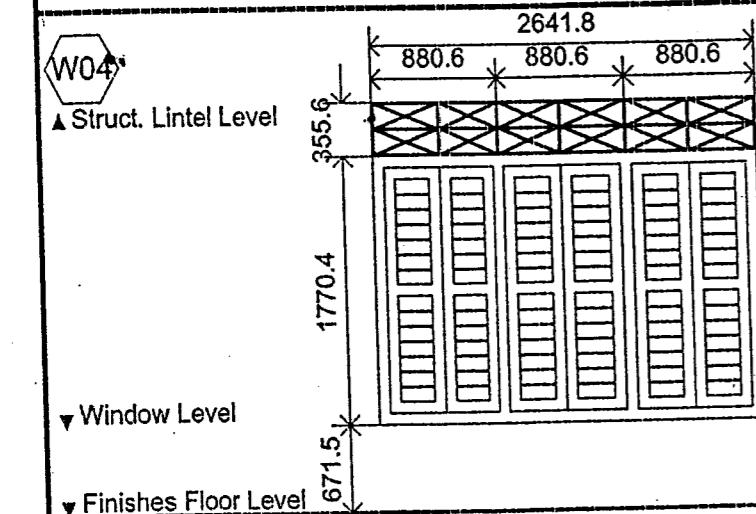

DESCRIPTION	2641.8 mm width x 1770.4 mm high (total length) double leaf h.w. timber panel louvres window with approved paint finish	DESCRIPTION	956.75 mm width x 1571.9 mm high (total length) double leaf h.w. timber panel louvres window with approved paint finish	DESCRIPTION	838.2 mm width x 652.75 mm high (total length) double leaf h.w. timber panel louvres window with approved paint finish
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LOCATION	QUANTITY	LOCATION	QUANTITY	LOCATION	QUANTITY
GROUND FLOOR	-	GROUND FLOOR	-	GROUND FLOOR	-
FIRST FLOOR	3	FIRST FLOOR	4	FIRST FLOOR	6
TOTAL	3	TOTAL	4	TOTAL	6

DRAWING NUMBER: DW/3


FOR TENDER

W07

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[RMG 336]

▼ Struct. Lintel Level

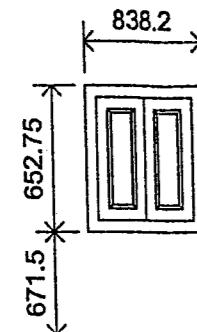

▼ Window Level

▼ Finishes Floor Level

▲ Struct. Floor Level

DESCRIPTION	838.2 mm width x 652.75 mm high (total length) double leaf h.w timber panel window with approved paint finish	DESCRIPTION		DESCRIPTION	
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LOCATION	QUANTITY	LOCATION	QUANTITY	LOCATION	QUANTITY
GROUND FLOOR	-	GROUND FLOOR		GROUND FLOOR	
FIRST FLOOR	7	FIRST FLOOR		FIRST FLOOR	
TOTAL	7	TOTAL		TOTAL	

DESCRIPTION	DESCRIPTION	DESCRIPTION
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DESCRIPTION	DESCRIPTION	DESCRIPTION			
LOCATION	QUANTITY	LOCATION	QUANTITY	LOCATION	QUANTITY
GROUND FLOOR		GROUND FLOOR		GROUND FLOOR	
FIRST FLOOR		FIRST FLOOR		FIRST FLOOR	
TOTAL		TOTAL		TOTAL	

DRAWING NUMBER: DW/4


FOR TENDER

...18/-



<p>D01</p> <p>▼ Struct. Lintel Level</p> <p>▼ Finishes Floor Level</p> <p>▲ Struct. Floor Level</p>	<p>D02</p> <p>▼ Struct. Lintel Level</p> <p>▼ Finishes Floor Level</p> <p>▲ Struct. Floor Level</p>	<p>D03</p> <p>▼ Struct. Lintel Level</p> <p>▼ Finishes Floor Level</p> <p>▲ Struct. Floor Level</p>	- 18 -		[RMG 336]
DESCRIPTION	1397 mm width x 2362.2 mm high double leaf hard wood timber panel door painted with approved paint finish	DESCRIPTION	750 mm width x 2100 mm high single leaf hard wood timber panel door painted with approved paint finish	DESCRIPTION	1130.3 mm width x 2006 mm high double leaf hard wood timber panel door painted with approved paint finish
LOCATION	QUANTITY	LOCATION	QUANTITY	LOCATION	QUANTITY
GROUND FLOOR	2	GROUND FLOOR	4	GROUND FLOOR	1
FIRST FLOOR	-	FIRST FLOOR	-	FIRST FLOOR	2
TOTAL	2	TOTAL	4	TOTAL	3
D04	<p>▼ Struct. Lintel Level</p> <p>▼ Finishes Floor Level</p> <p>▲ Struct. Floor Level</p>		D05	<p>▼ Struct. Lintel Level</p> <p>▼ Finishes Floor Level</p> <p>▲ Struct. Floor Level</p>	
DESCRIPTION	1130.3 mm width x 2082 mm high double leaf hard wood timber panel door painted with approved paint finish		DESCRIPTION	1130.3 mm width x 2082 mm high double leaf hard wood timber panel door painted with approved paint finish	
LOCATION	QUANTITY	LOCATION	QUANTITY	LOCATION	QUANTITY
GROUND FLOOR	-	GROUND FLOOR	-	GROUND FLOOR	
FIRST FLOOR	8	FIRST FLOOR	3	FIRST FLOOR	
TOTAL	8	TOTAL	3	TOTAL	

DRAWING NUMBER: DW/5

FOR TENDER

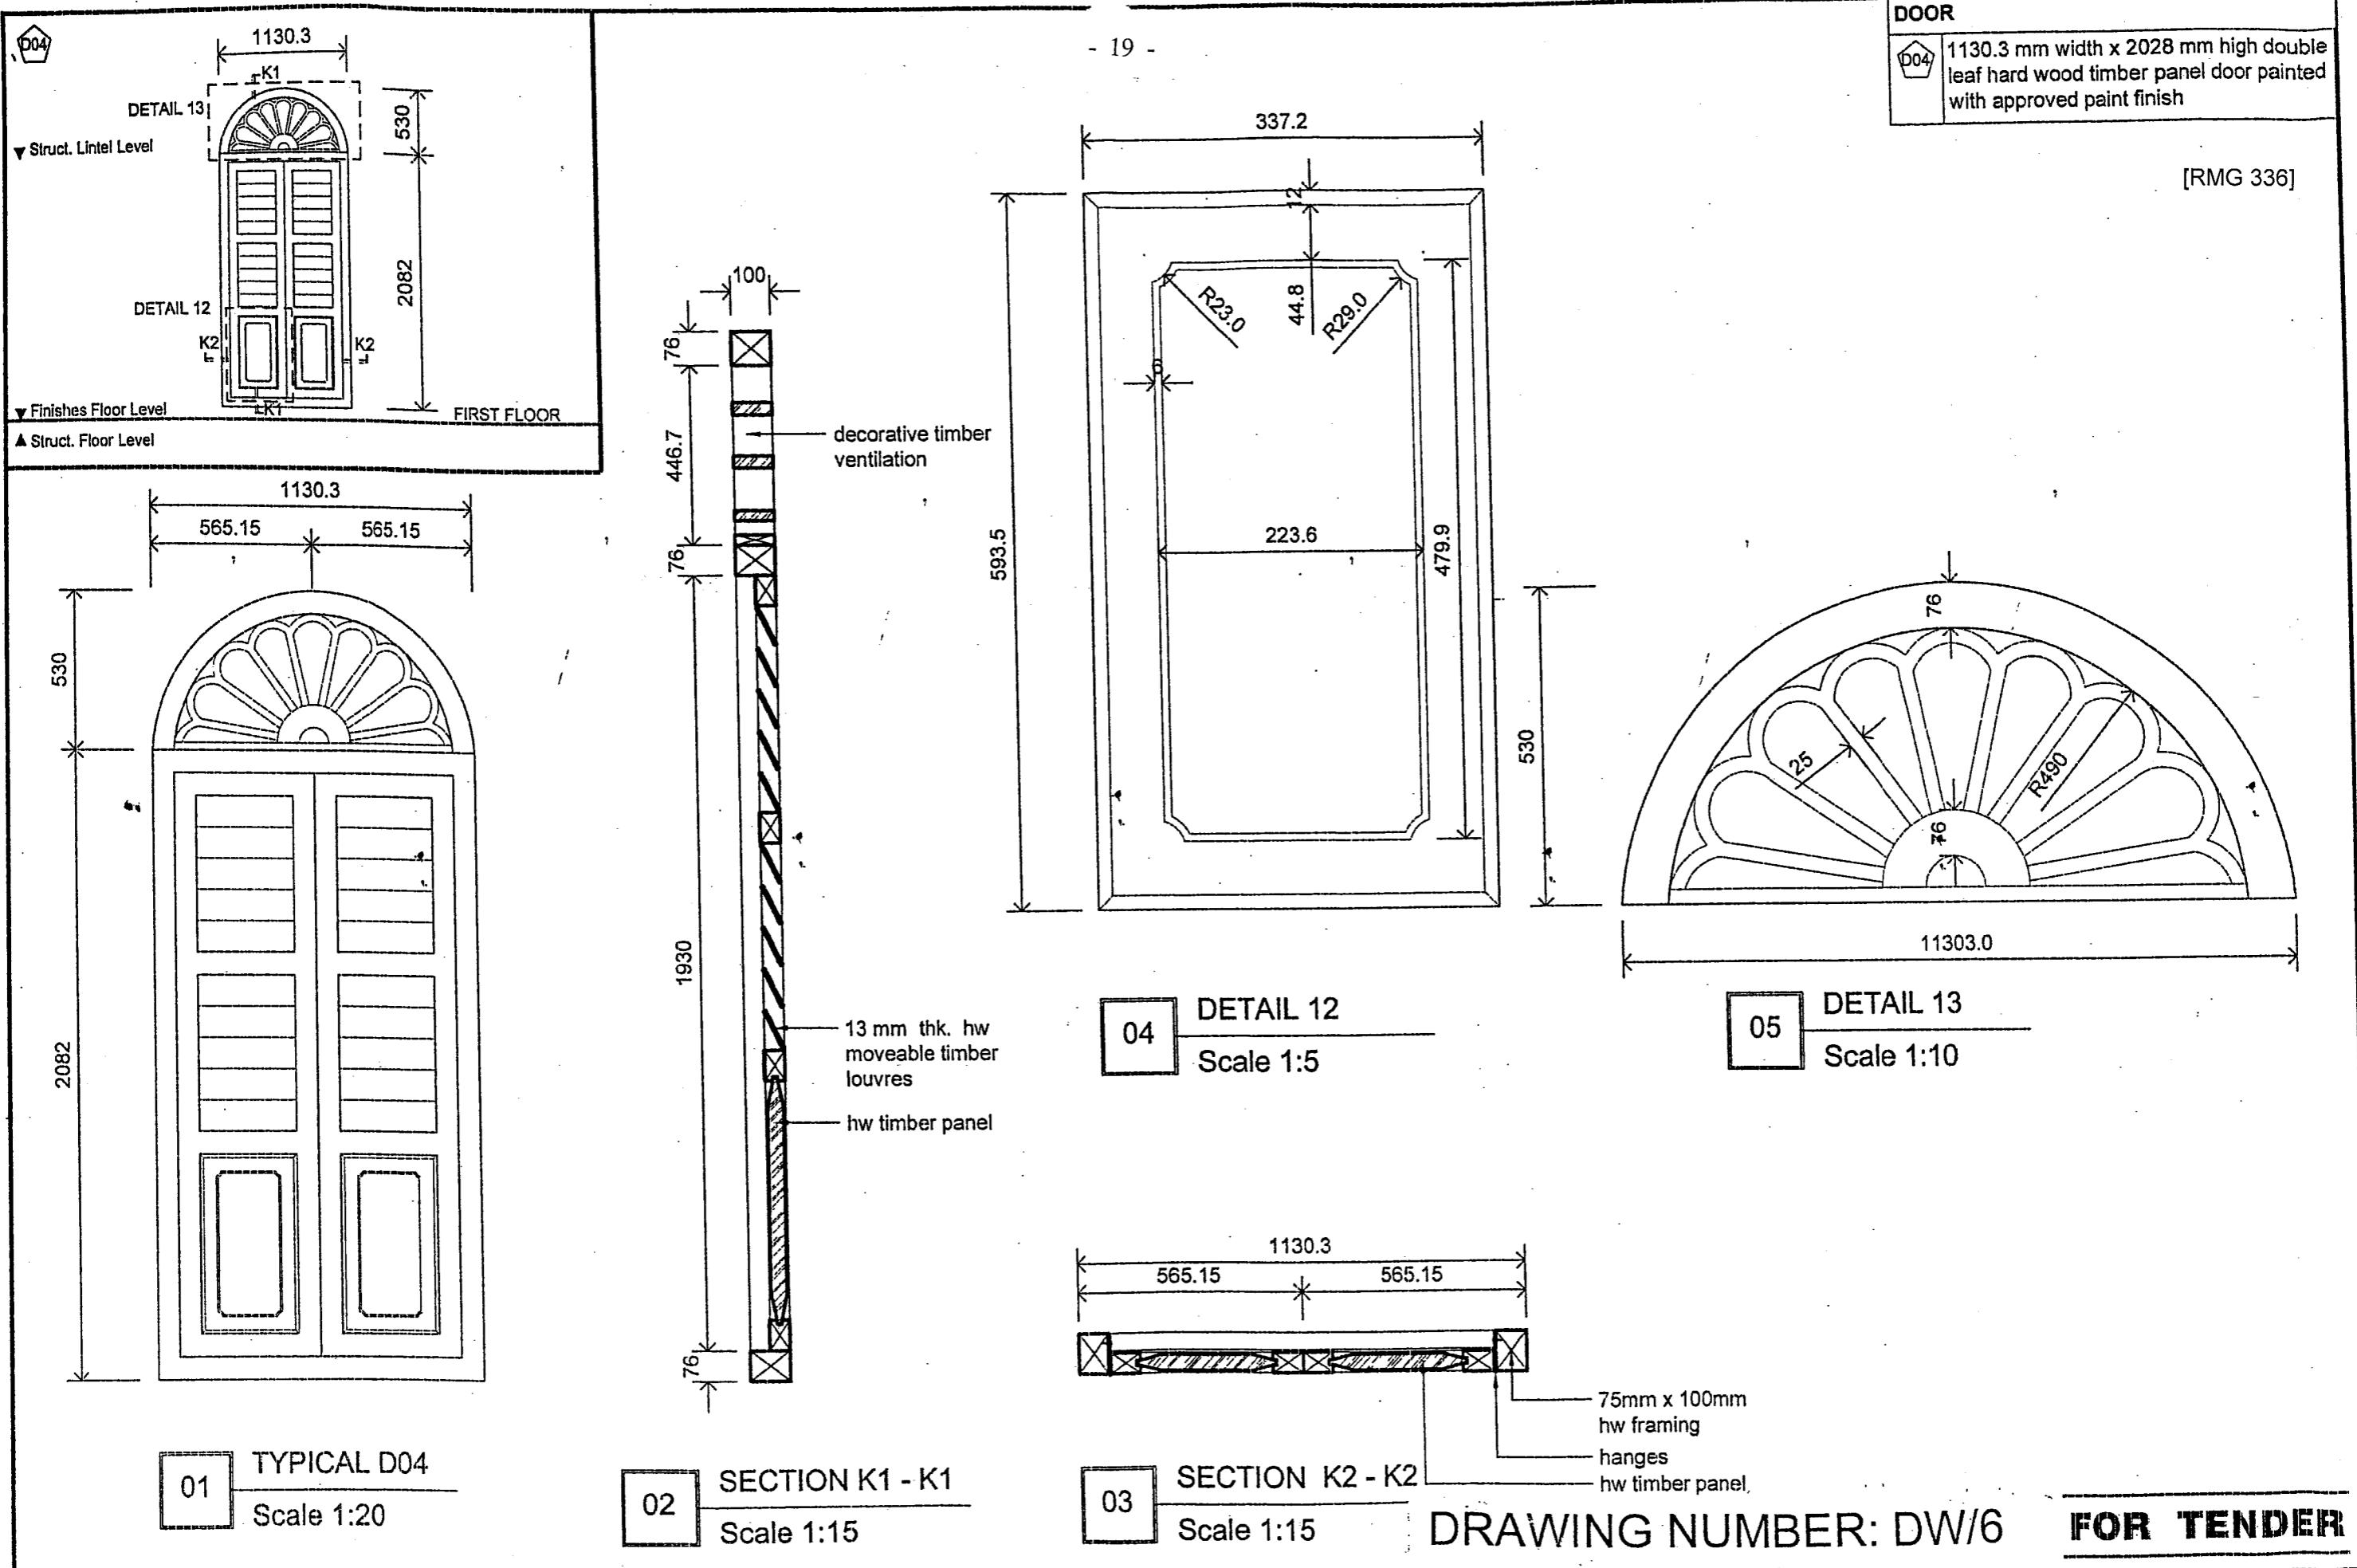


D03

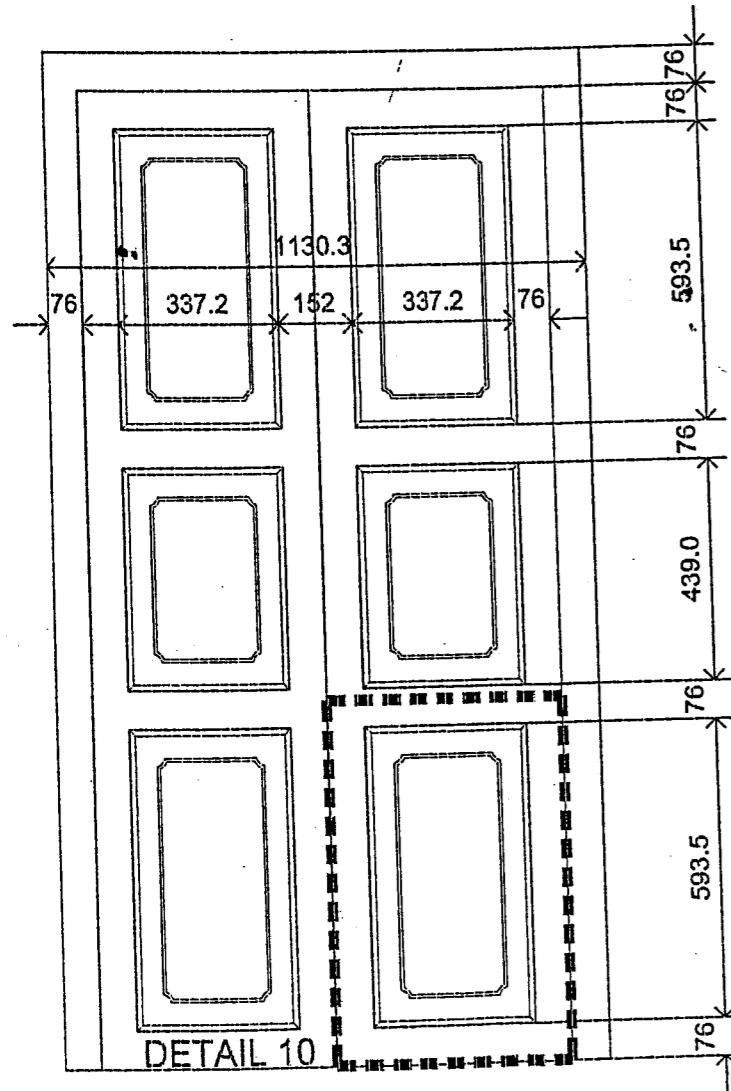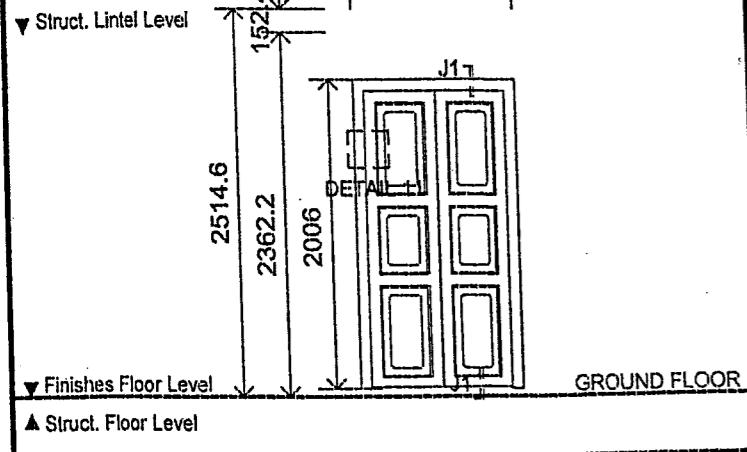

01 TYPICAL D03
Scale 1:15

- 20 -

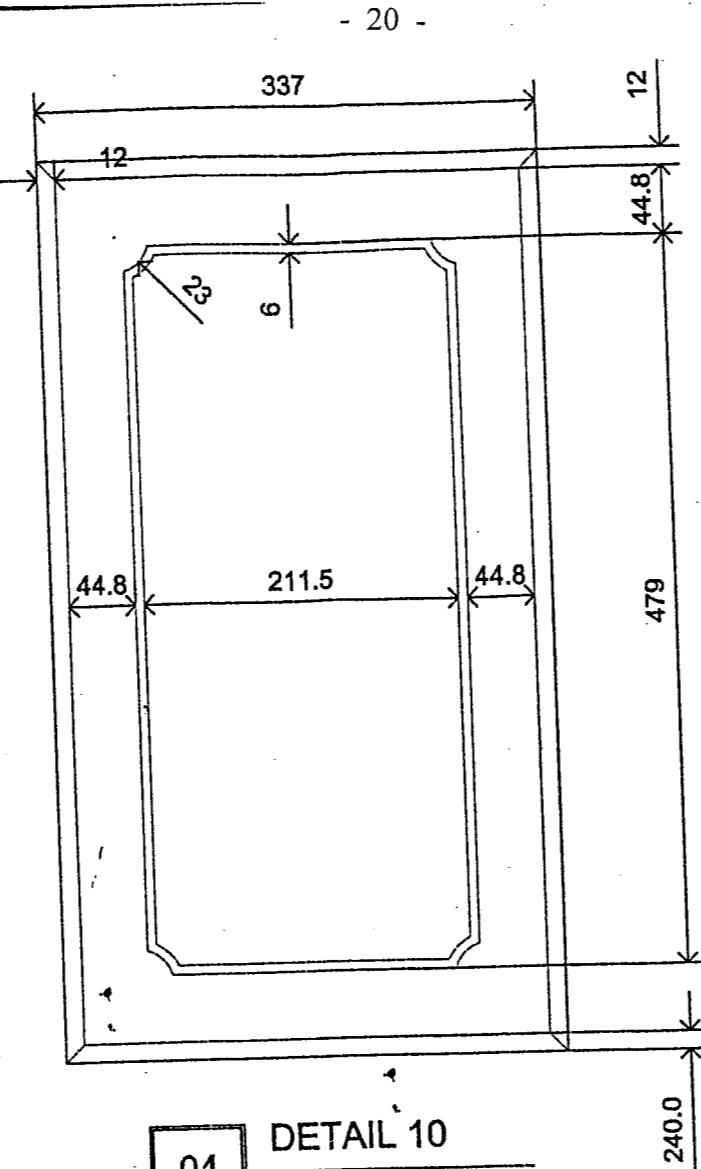

02 DETAIL 11
Scale 1:5

